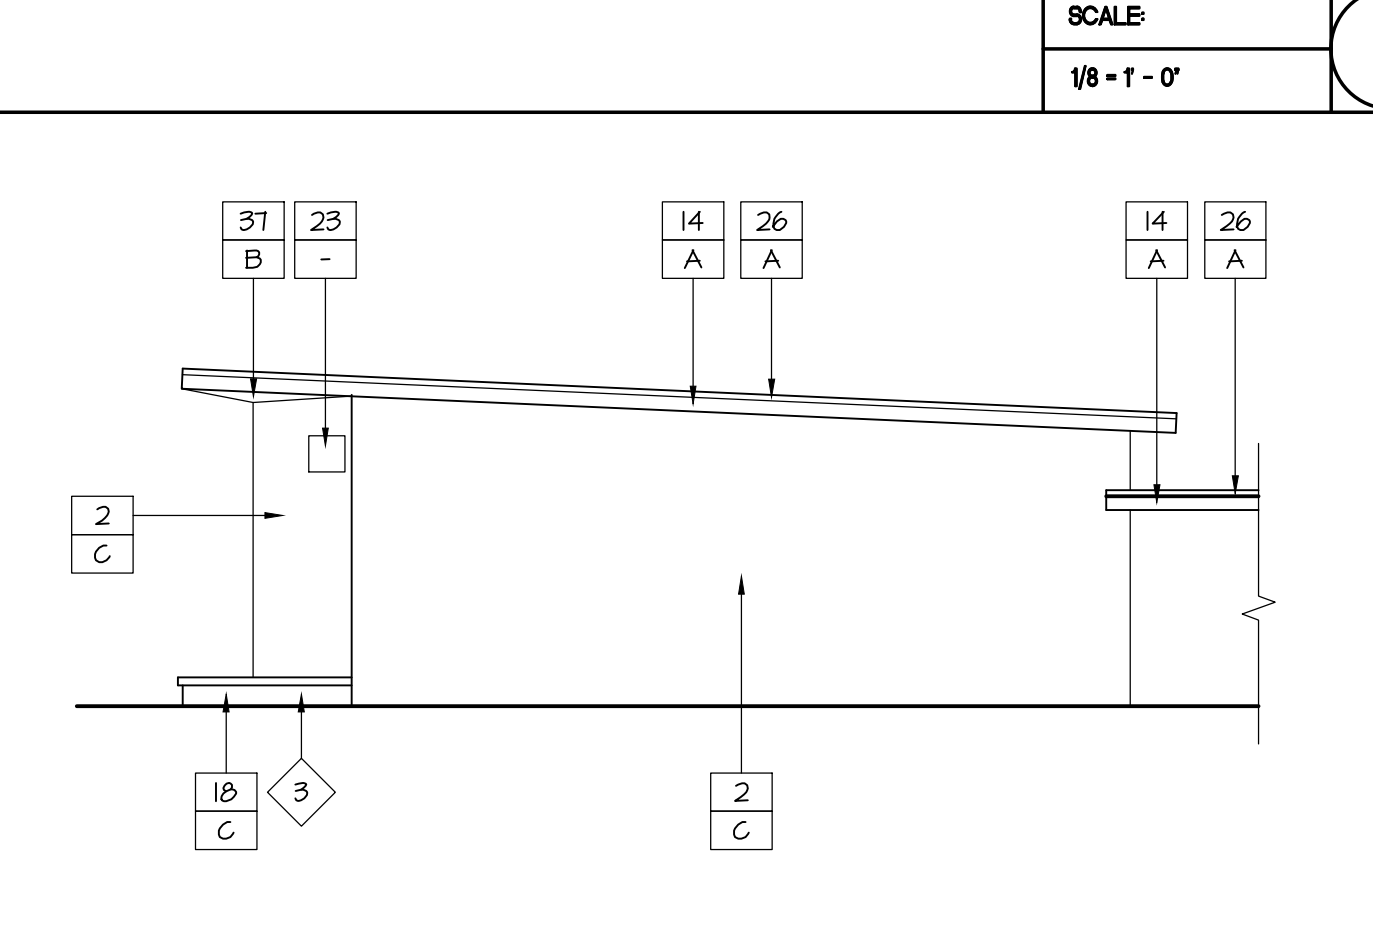
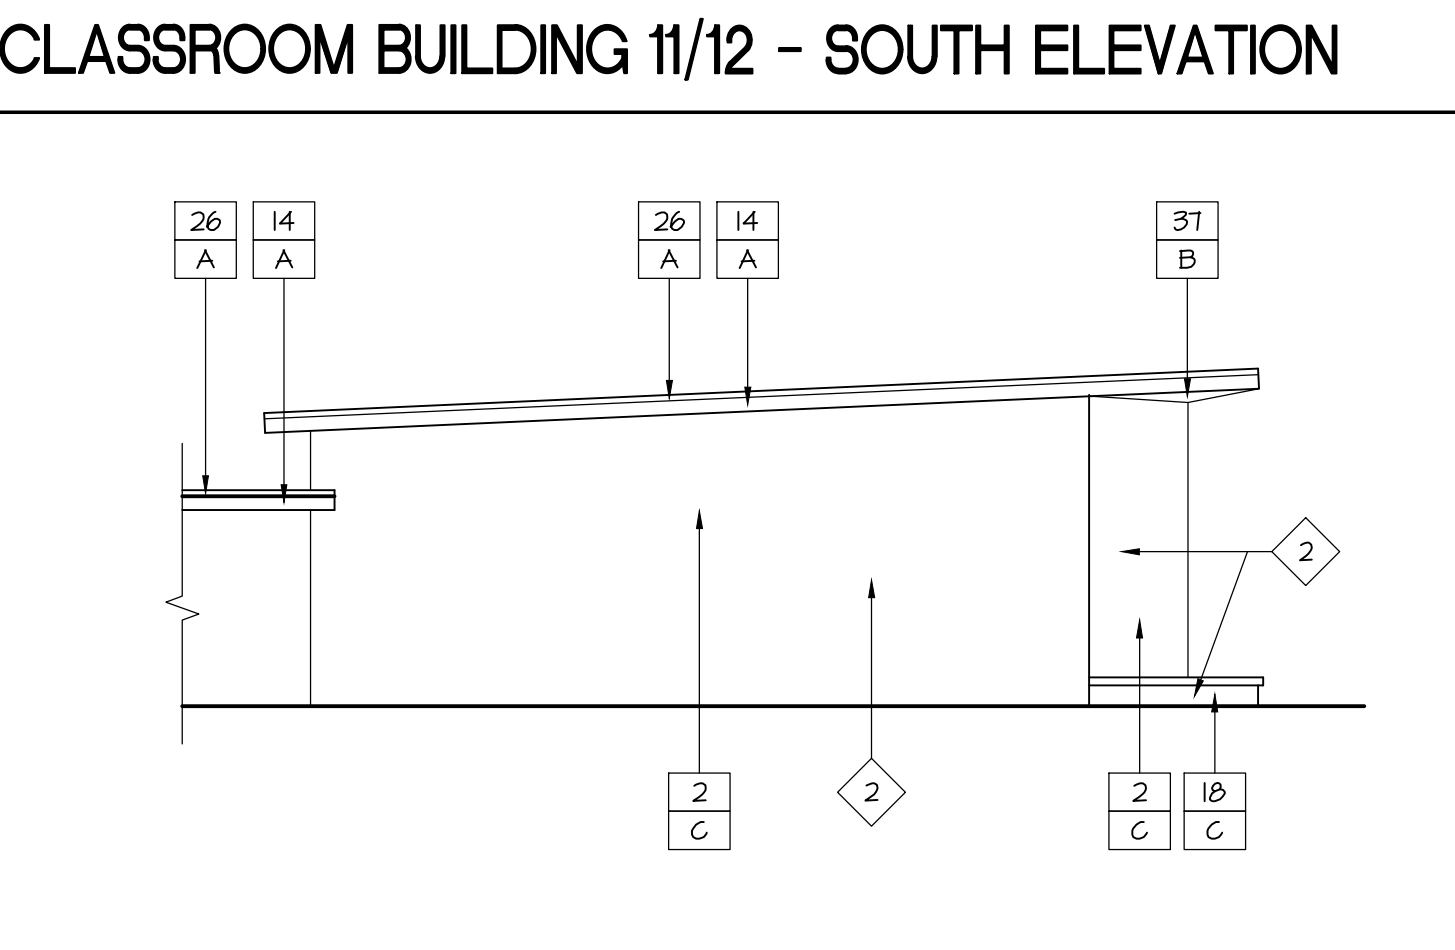
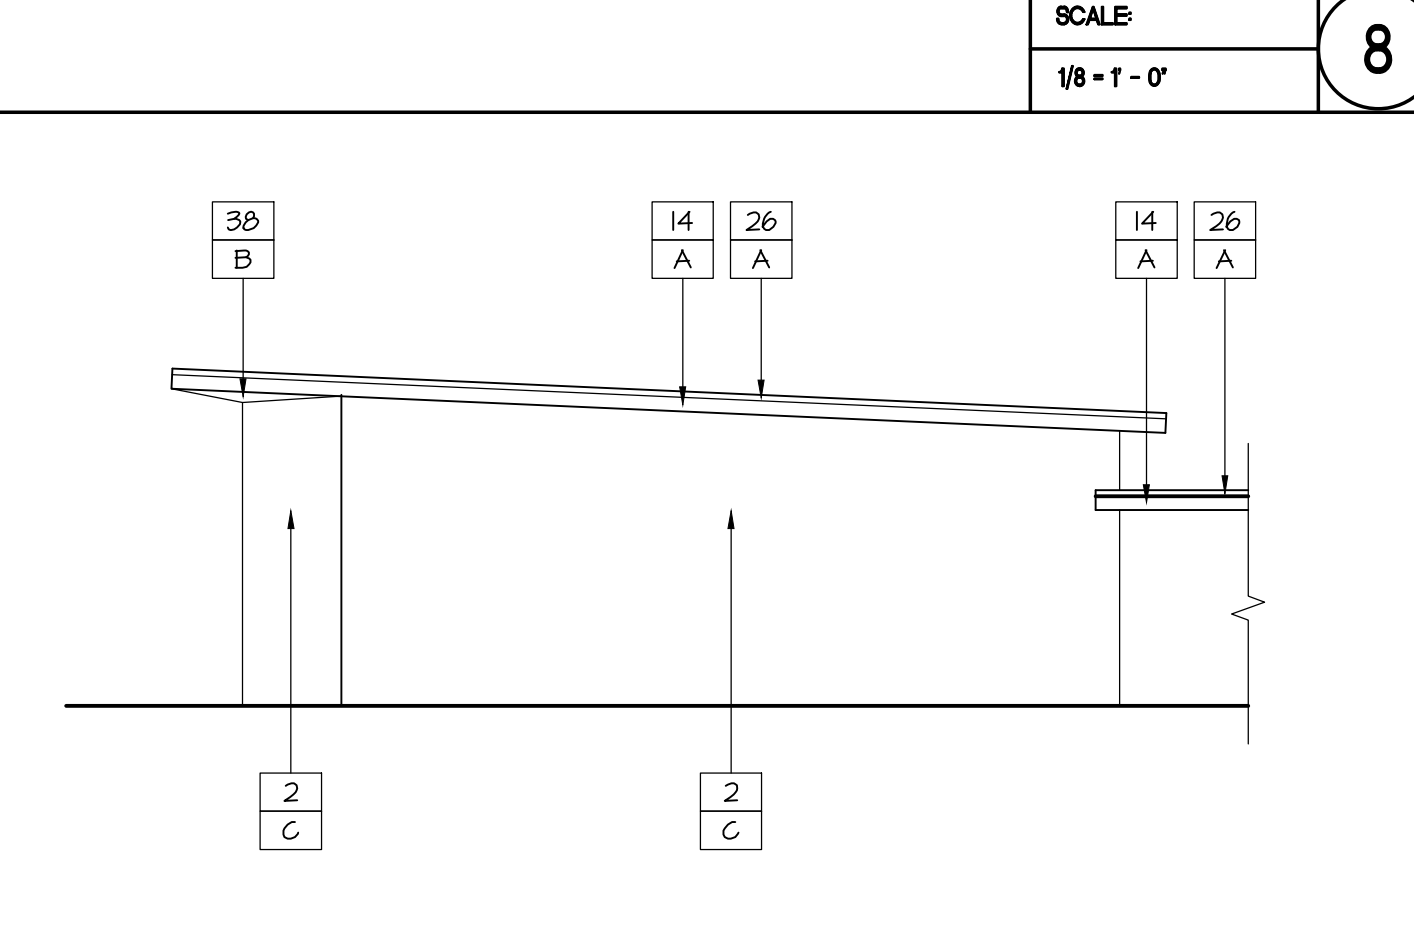
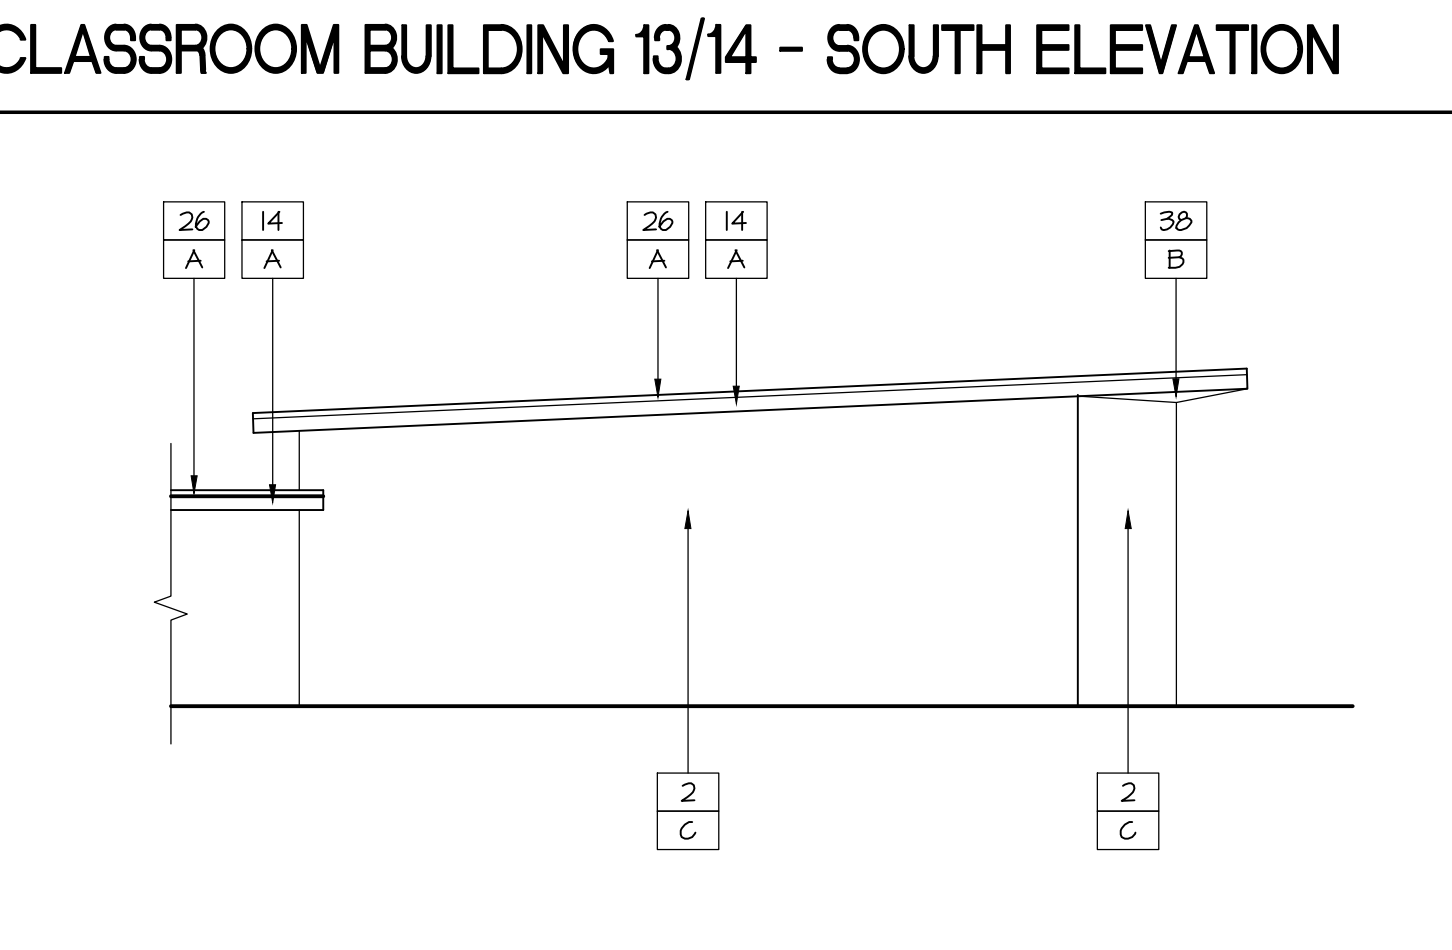
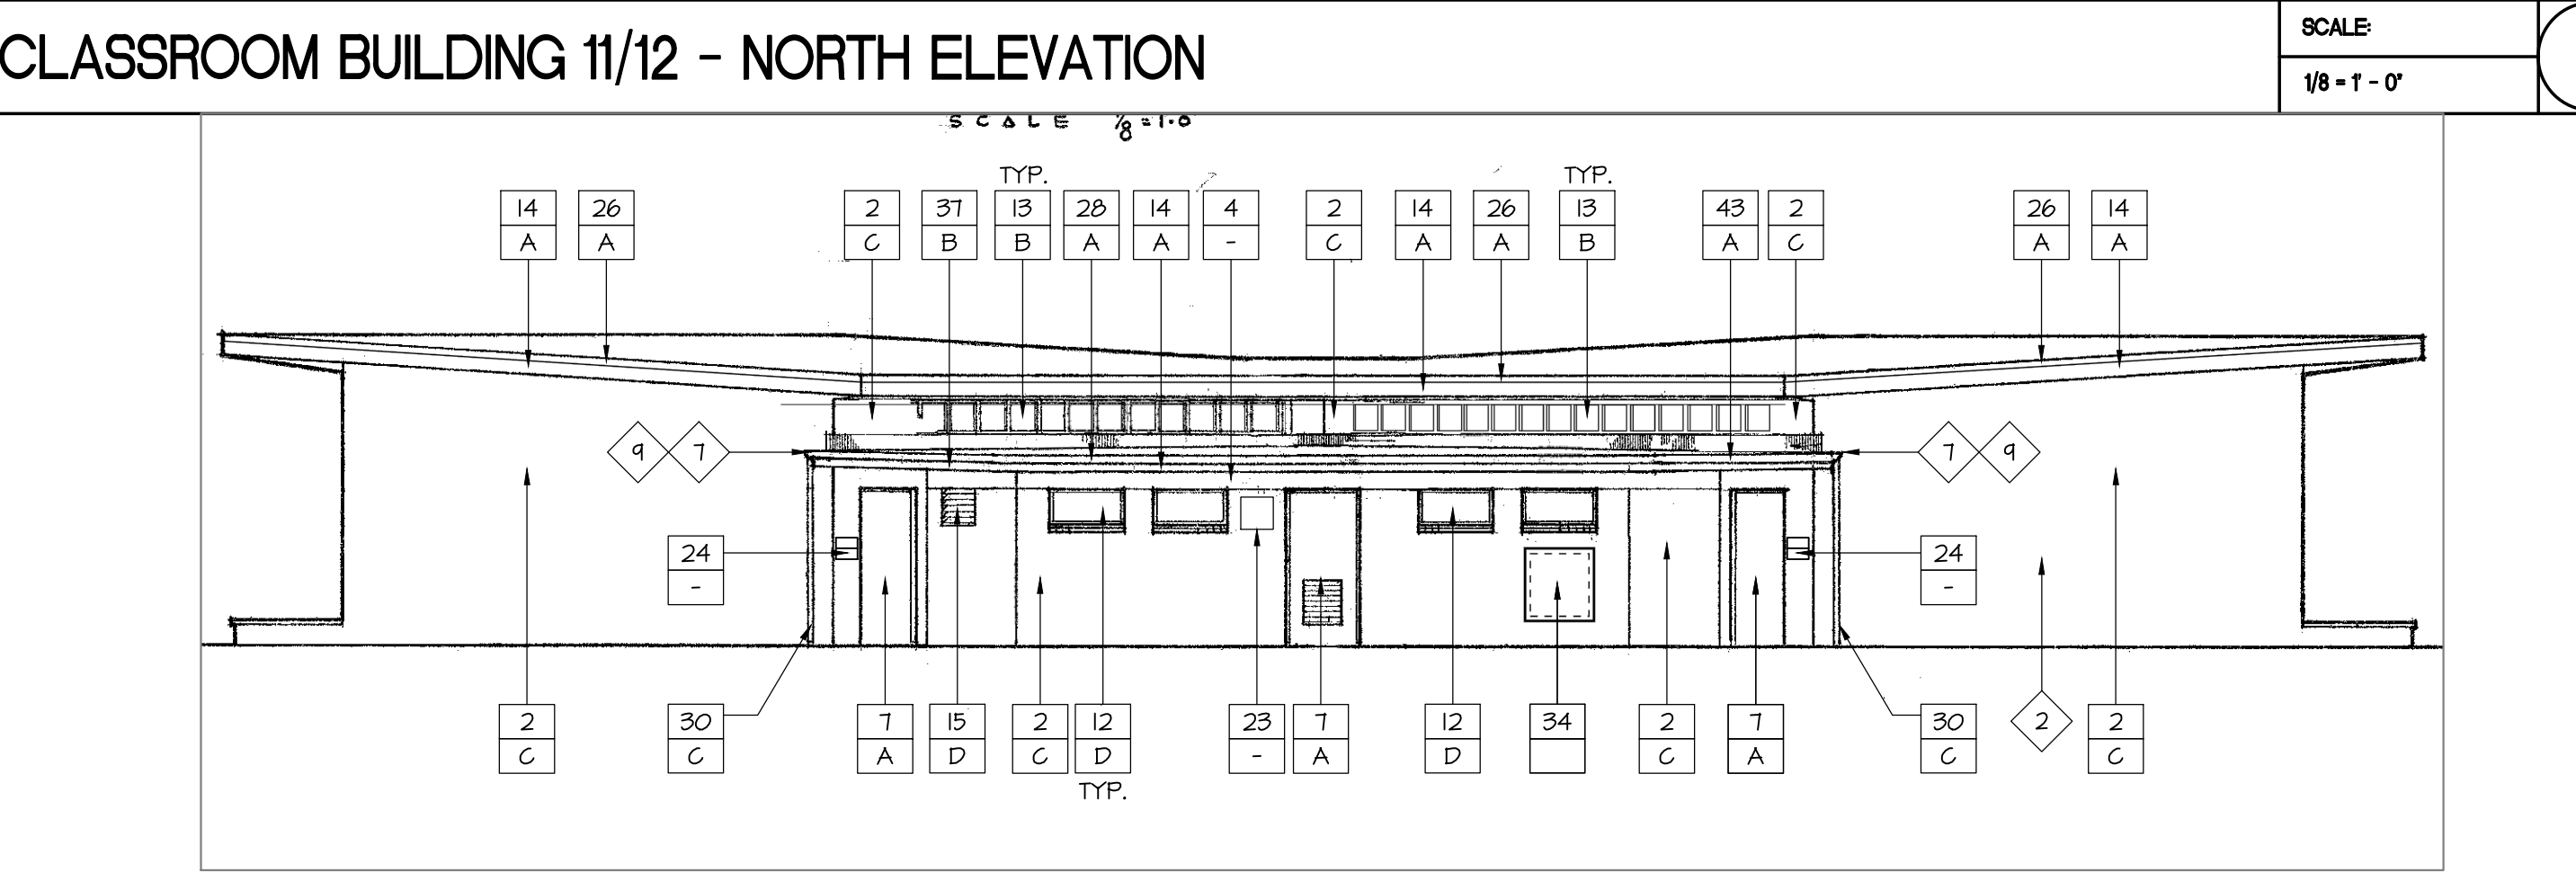
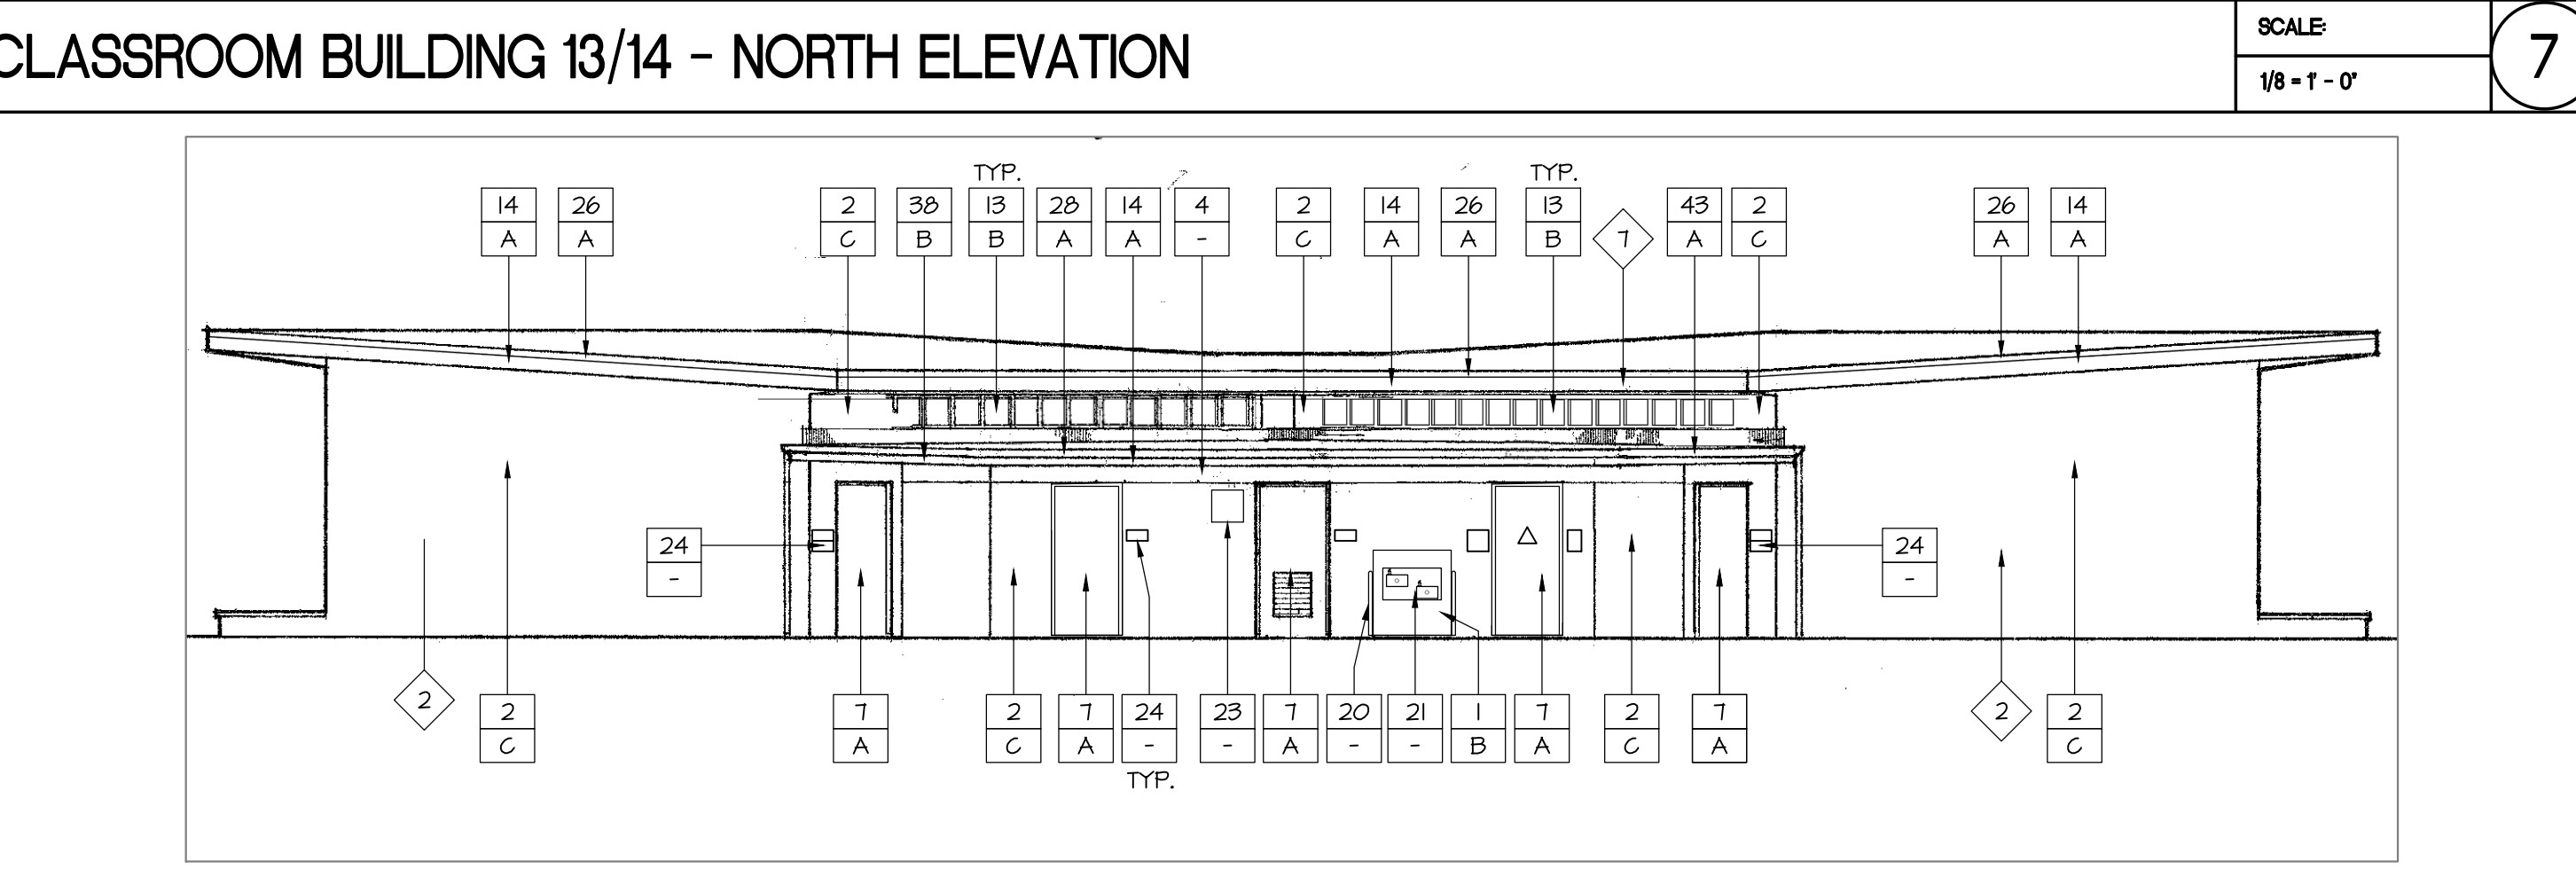
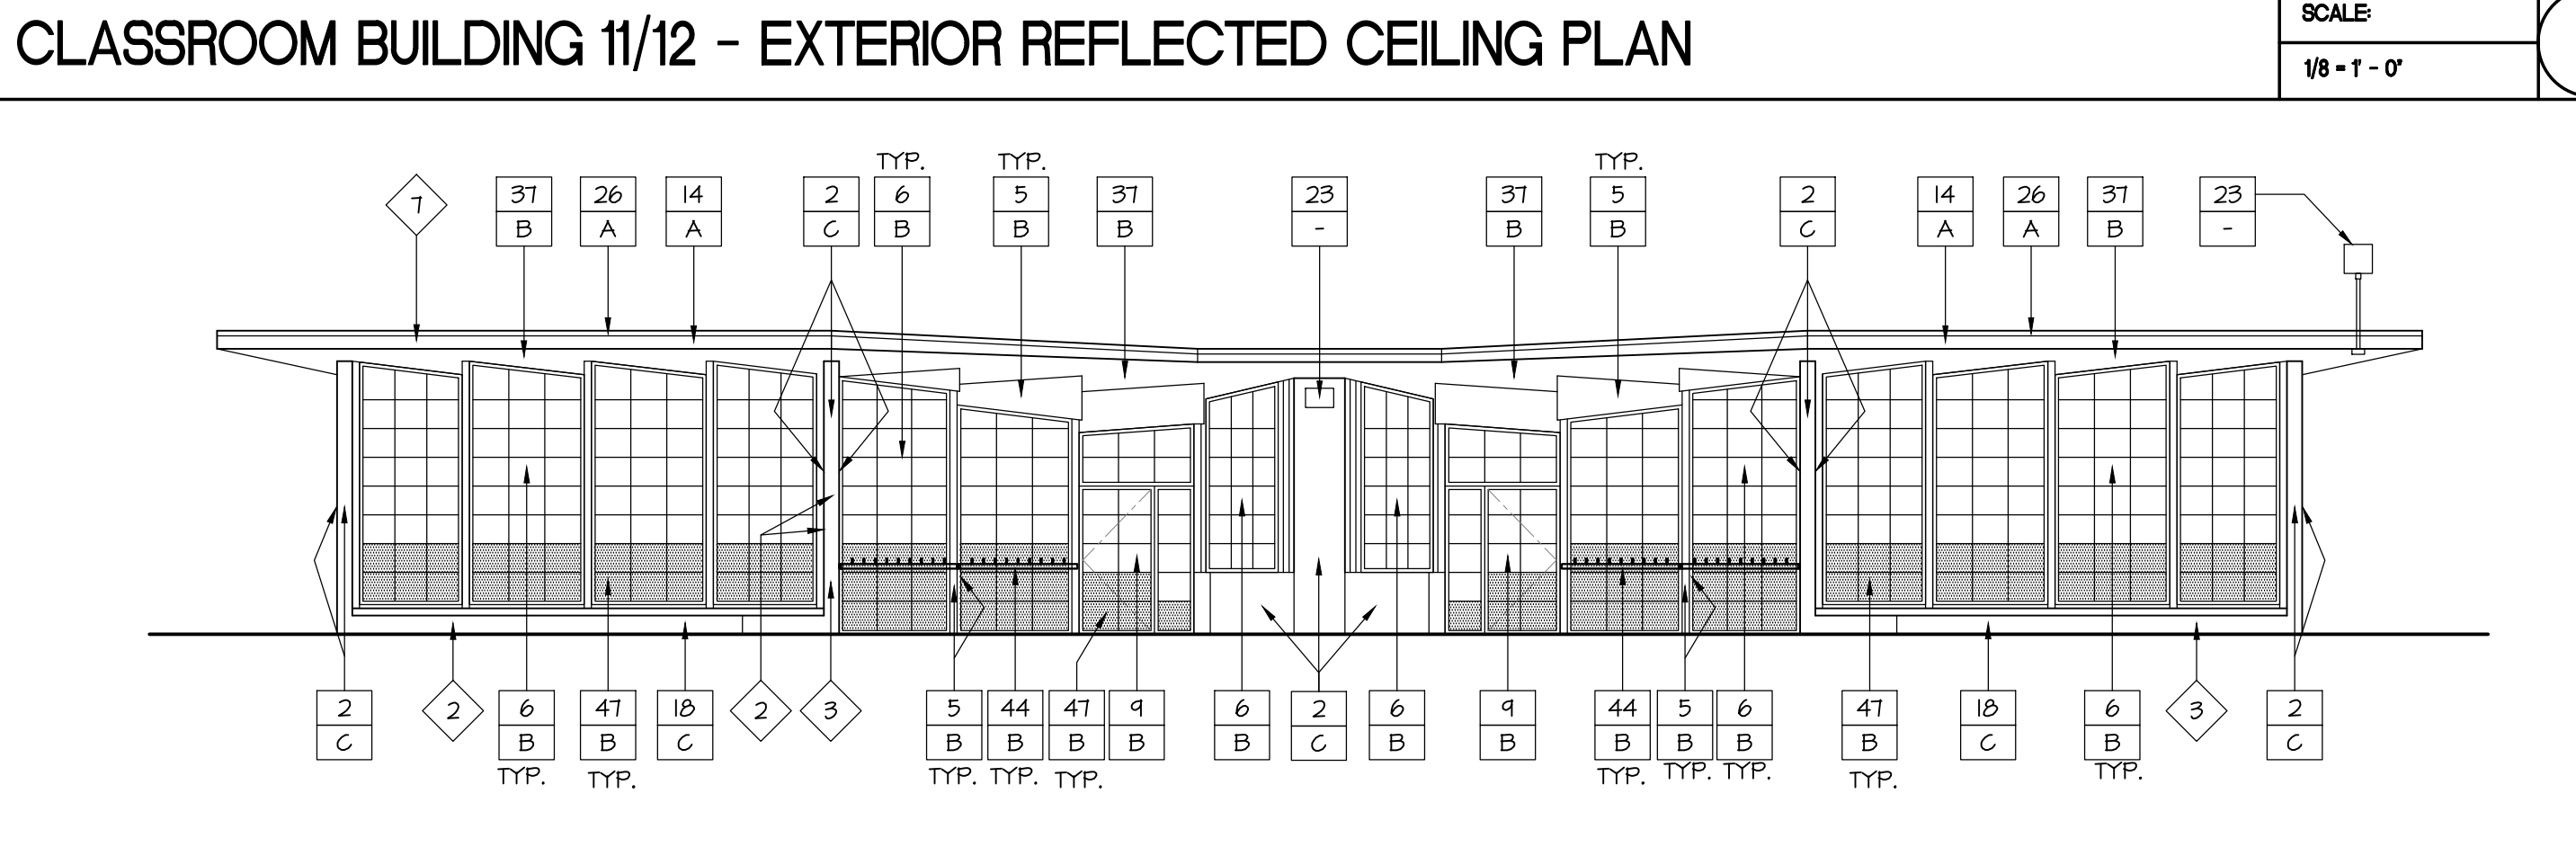
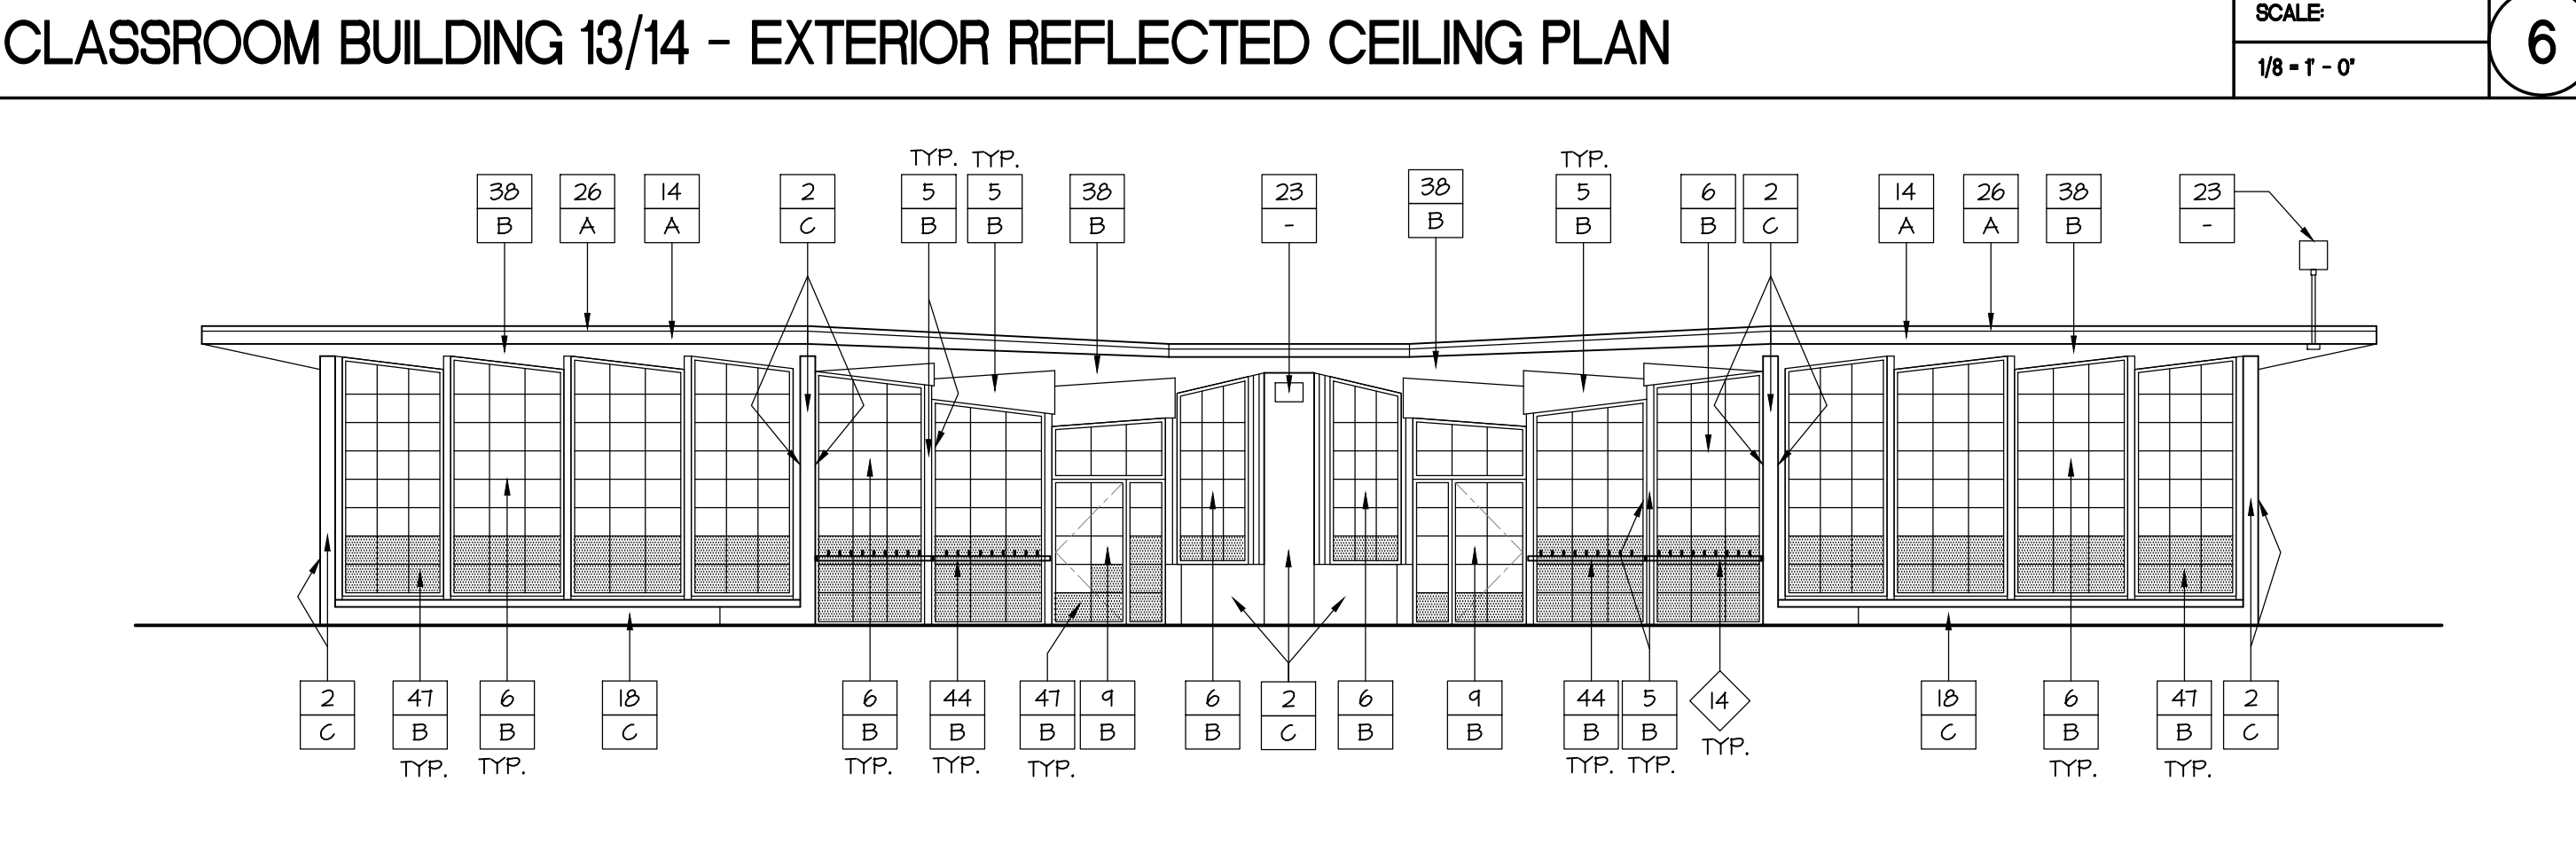
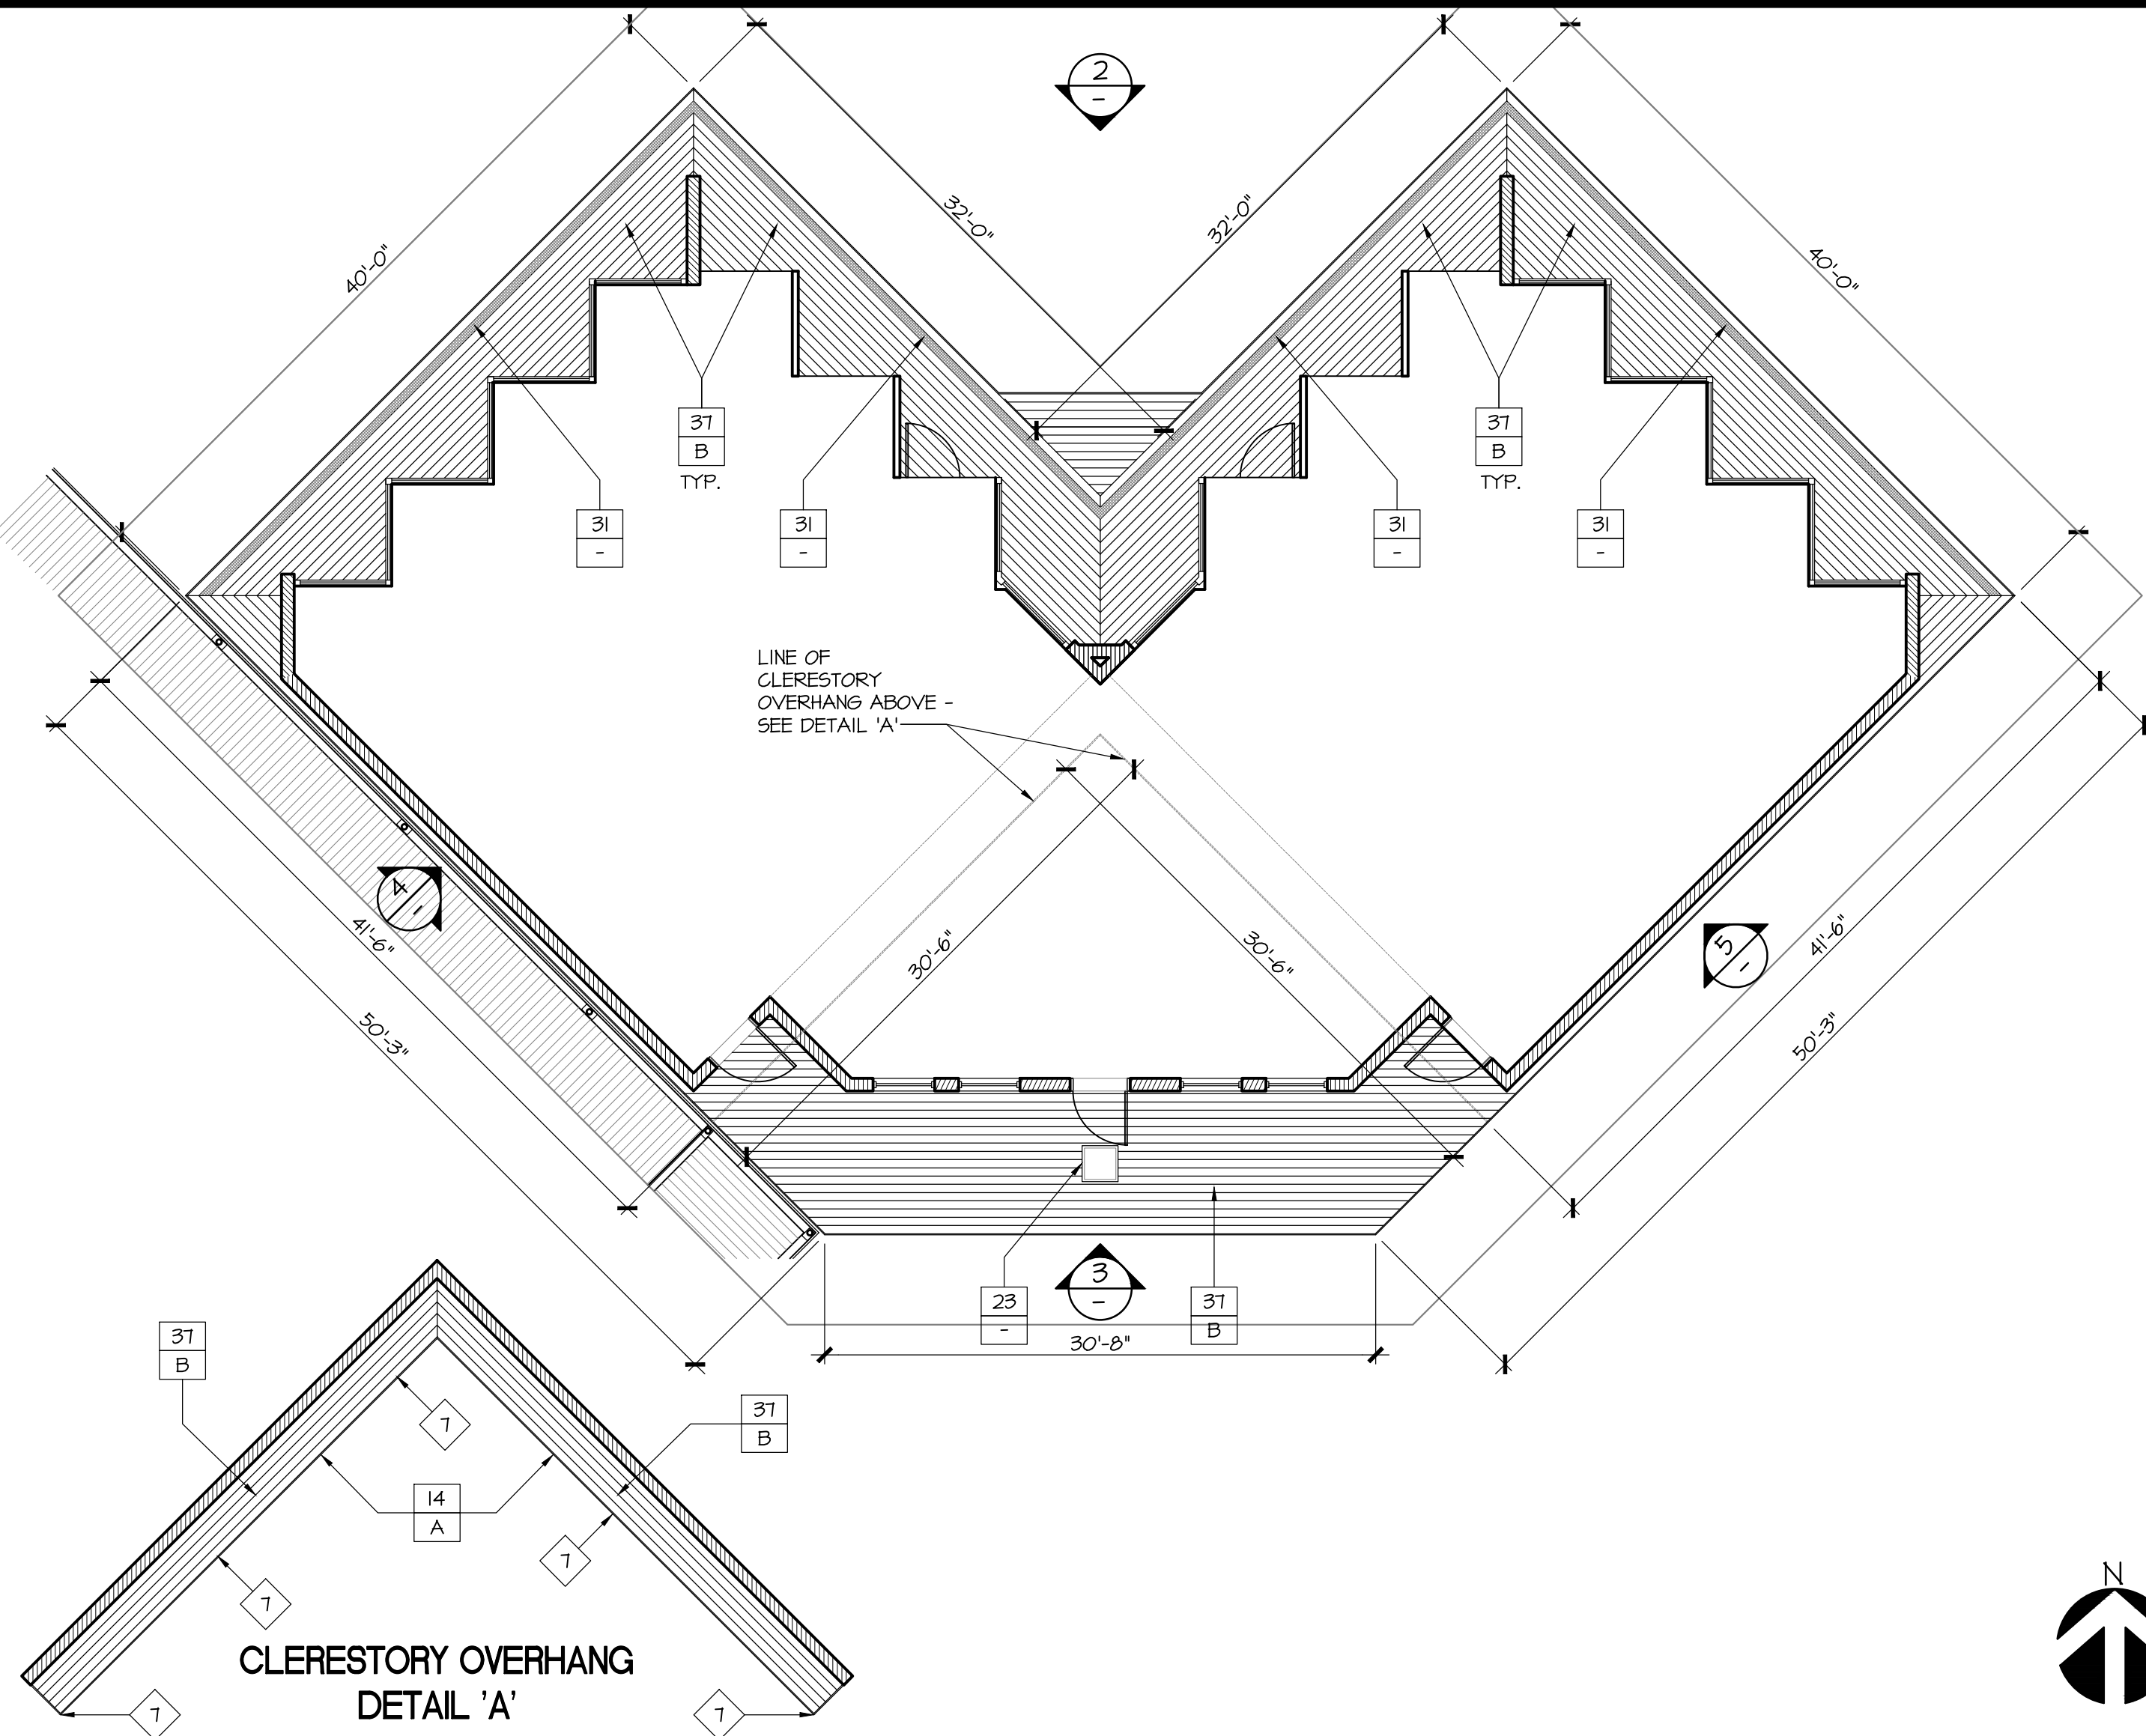
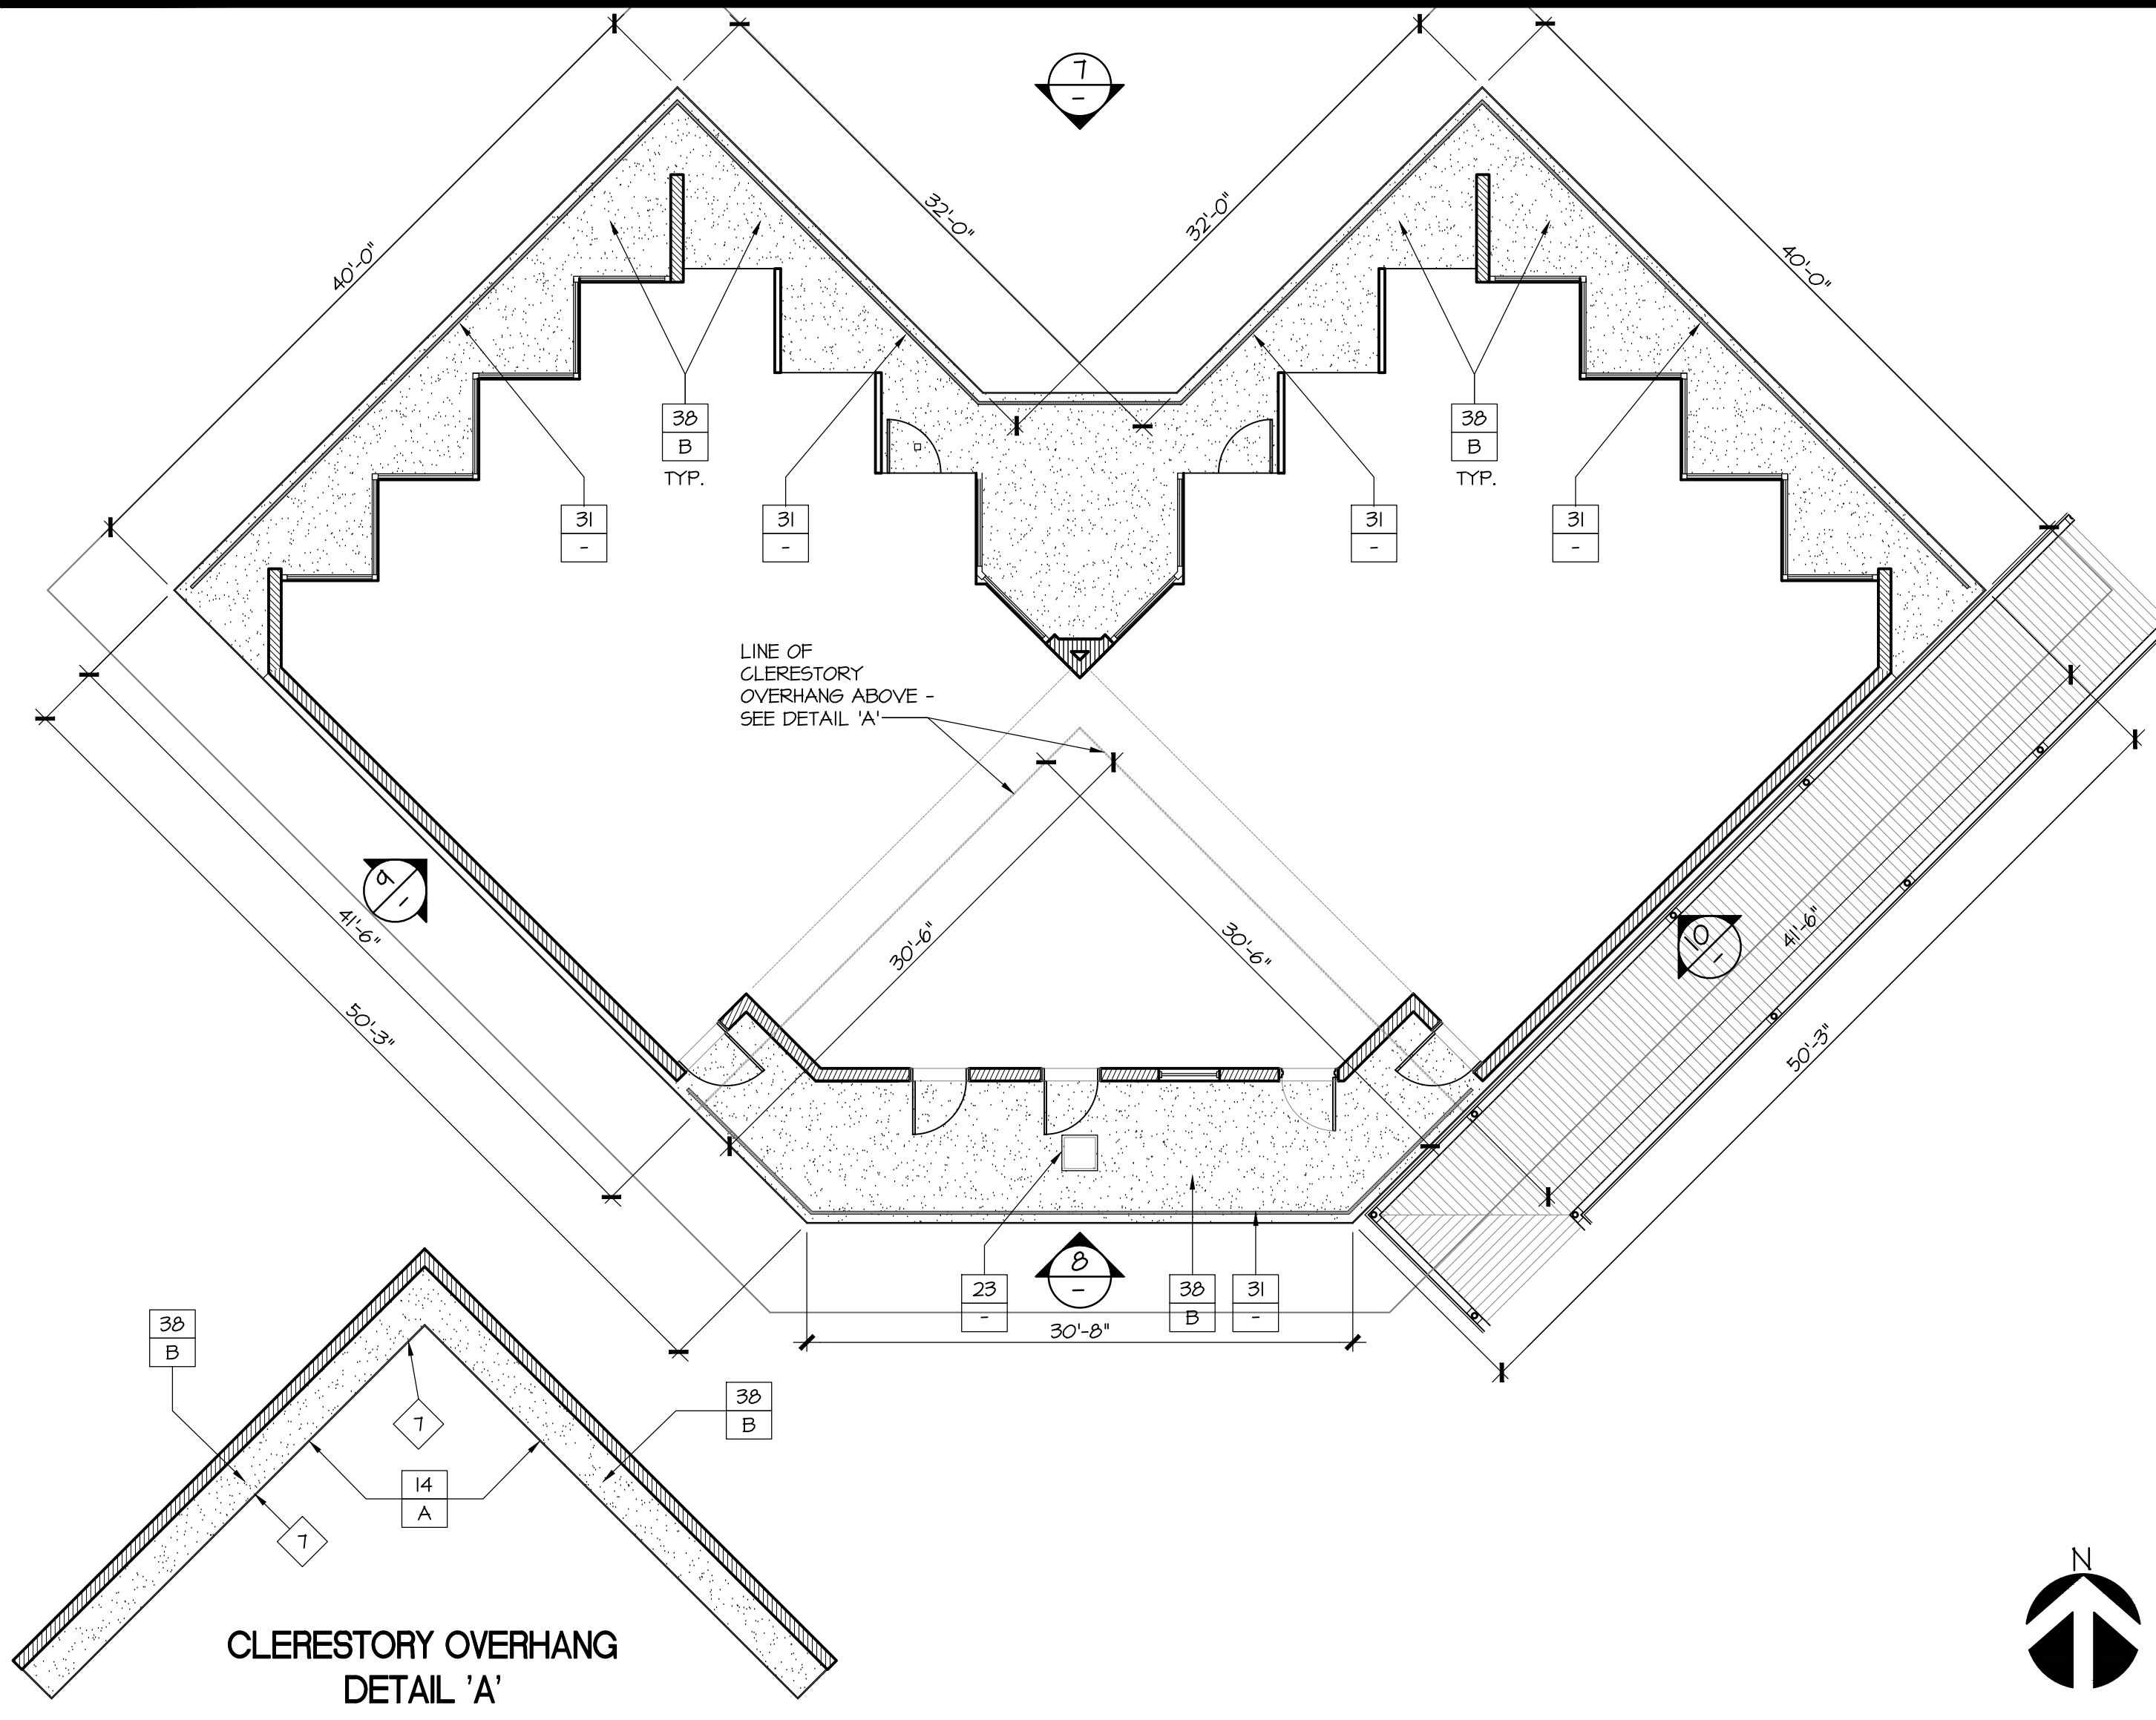


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### CONSTRUCTION KEYED NOTES

(ALL ITEMS INDICATED ARE EXISTING UNLESS NOTED)

1	PLASTER	26	METAL FLASHING/COPING
2	BRICK - SEALED / EXPOSED	27	STEEL FRAMING
3	BRICK - PAINTED	28	METAL GUTTER
4	CONCRETE	29	SCAFFER
5	PLYWOOD PANELING ON HALL / UNDERSIDE OF ROOF OVERHANG	30	STEEL / SHEET METAL DOWNSPOUT
6	STOREFRONT SYSTEM	31	VENT WITH METAL MESH SCREEN / GRATE
7	METAL DOOR / FRAME	32	SCHOOL NAME ADHERED METAL LETTERING
8	HOOD DOOR / FRAME	33	BULLETIN BOARDS/SIGNAGE ETC.
9	DOOR - STOREFRONT	34	FIRE EXTINGUISHER / FIRE HOSE ALCOVE
10	HOOD TRIM / FRAME	35	CHAINLINK FENCINGS/GATES / METAL SCREEN
11	WINDOW FRAME - HOOD	36	THROUGH-IRON FENCINGS/GATES
12	WINDOW FRAME - METAL	37	UNDERSIDE OF ROOF OVERHANGS / COVERED WALKWAY - 1X6 SHIPLAP SIDING
13	CLERESTORY WINDOW SYSTEM-METAL	38	UNDERSIDE OF ROOF OVERHANG / COVERED WALKWAY - GEMENT PLASTER
14	WOOD FASCIA	39	UNDERSIDE OF ROOF OVERHANGS / COVERED WALKWAY - EXPOSED HOOD FRAMING
15	LOUVER - METAL / WOOD	40	UNDERSIDE OF COVERED WALKWAY / LUNG SHEDLER - CORRUGATED METAL
16	HOOD SIDING	41	BARB UNIT
17	PLANTER - CONCRETE	42	REPLACE FULL BOX COVER IF RUSTED
18	PLANTER - BRICK	43	NEW ROOF GUTTER
19	STEEL TUBE/PIPE COLUMN	44	WOOD BACKPACK HANGER
20	PIPE RAILING	45	METAL PLATE
21	DRINKING FOUNTAIN	46	NEW METAL DOWNSPOUT
22	CERAMIC TILE MAINSLOPE	47	STOREFRONT GLASS PANE PAINTED TO MATCH CAMPUS
23	LIGHT, SPEAKER, ELECTRICAL BOX ETC.	48	HOOD BEAM
24	SIGNAGE. REPLACE AS REQUIRED TO MATCH CAMPUS	49	METAL FASCIA
25	HOOD SKIRTING		

### REPAIR KEYED NOTES

- AREA OF DAMAGED / CRACKED PLASTER. REPAIR AND PATCH WITH NEW PLASTER TO MATCH (E).
- BRICK INFILL OR DISCOLORED BRICK. LIGHTLY VAPORBLAST ENTIRE BRICK WALL SURFACE. COAT WITH ANTI-GRAFFITI COATING. INSPECT ALL BRICK WORK PRIOR TO PROCEEDING.
- DAMAGED / CRACKED BRICK / CONCRETE. REPLACE OR PATCH TO MATCH (E).
- EXPOSED CONCRETE LINTEL. REPAIR CRACKS IF ANY. PAINT TO MATCH ADJACENT BRICK COLOR.
- DAMAGED HOOD PANELING. REMOVE AND REPLACE WITH NEW HOOD PANELING.
- CRACKED / DAMAGED WINDOW PANE. REMOVE AND REPLACE WITH NEW GLASS TO MATCH EXISTING.
- DAMAGED WOOD FASCIA. REMOVE AND REPLACE WITH NEW WOOD FASCIA TO MATCH EXISTING. REPLACE METAL DRIP EDGE AS REQUIRED WHERE DAMAGED. DETAIL 6 / 73.0
- DAMAGED METAL FLASHING / COPING. REMOVE AND REPLACE WITH NEW FLASHING / COPING TO MATCH EXISTING.
- DAMAGED METAL GUTTER. REMOVE AND REPLACE AS NEEDED WITH NEW METAL GUTTER. DETAIL 7 / 3.0 PATCH WHERE GUTTER WAS REPLACED AND PATCH ROOFING AS NEEDED.
- DAMAGED DOWNSPOUT. REMOVE AND REPLACE AS NEEDED WITH NEW DOWNSPOUT TO MATCH (E).
- DOWNSPOUT. PROVIDE MISSING / DAMAGED CONNECTION FROM GUTTER TO DOWNSPOUT. SEE DETAIL 173.0.
- DAMAGED VENT REMOVE AND REPLACE WITH NEW TO MATCH (E). FOR SOFFIT VENT. REMOVE PORTION OF ADJACENT PLASTER OR WOOD AS REQUIRED AND PROVIDE NEW PLASTER / WOOD WHERE REMOVED. SEE DETAIL 2 / 73.0.
- DAMAGED WOOD SKIRTING REMOVE AND REPLACE WITH NEW SKIRTING AS NEEDED TO MATCH (E).
- REMOVE AND REPLACE DAMAGED BACKPACK HANGER WOOD PLATE.
- REMOVE (E) LOUVERED OPENING AND PROVIDE NEW. SEE DETAIL 13 - 4 / 1473.0.
- SAND / CUT UNUSED METAL POST ABOVE FINISH GRADE AND CAP THE OPENING. PROTECT THE CONCRETE AND WALL AROUND THE FOOT FROM ANY DAMAGE DURING REMOVAL.
- SCHOOL ADHESIVE LOGO. REMOVE. DISTRICT TO REPLACE WITH NEW ADHESIVE LOGO / STICKER.
- DAMAGED WOOD SIDING REMOVE AND REPLACE AS REQUIRED.
- DAMAGED WOOD PLANK CEILING TO BE REMOVED AND REPLACED IN AREA INDICATED IN DRAWING.
- ROOM SIGNAGE REMOVE AND REPLACE WITH NEW SIGNAGE PER DISTRICT'S APPROVAL.
- REMOVE WOOD LATTICE OVER LOUVERED OPENING.
- HOLE IN BRICK MASONRY. FILL WITH COLORED GROUT TO MATCH BRICK.
- DAMAGED ELECTRICAL BOX / SPEAKER TO BE REPLACED BY THE DISTRICT BEFORE PAINTING WORK BEGINS. REFER TO TYP. PAINTING AND CONSTRUCTION NOTES #5.
- DAMAGED METAL FASCIA REMOVE AND REPLACE WITH NEW METAL FASCIA TO MATCH EXISTING. REPLACE METAL DRIP EDGE AS REQUIRED WHERE DAMAGED.
- WOOD PLANK / SKIRTING WITH LOOSE EDGE. NAIL / FIX AS REQUIRED.

### COLOR NOTES

COLOR / MANUFACTURER


- A ACCENT COLOR DUNN EDWARDS - "LAKE CENTER BLUE" EV5H0-2 EVERSHIELD EXT 5/6
- B BASE COLOR DUNN EDWARDS - "THATCHED ROOF" D661TT
- C CLEAR SEALER "STONETONE" 44CF-1 BY EPMAR (2 COATS)
- D PAINT COLOR TO MATCH (E) BRICK FROM DUNN EDWARDS TO BE DECIDED BY DISTRICT

### LEGEND

6 - MATERIAL INDICATION  
A - COLOR INDICATION

### TYP. PAINTING + CONSTRUCTION NOTES

- ALL REPAIR WORK INDICATED IN REPAIR KEYED NOTES TO BE DONE PRIOR TO START OF PAINTING WORK.
- REFER TO SPECIFICATIONS FOR PAINTING PREPARATION OF DIFFERENT MATERIALS AND SURFACES PRIOR TO START OF PAINTING WORK.
- FIELD VERIFY ALL CONDITIONS PRIOR TO PROCEEDING.
- PRIOR TO THE START OF CONSTRUCTION OR ORDERING MATERIALS, PROVIDE THE ARCHITECT WITH A COMPLETE COLOR PALLETTE OF ALL MATERIALS FOR REVIEW.
- HASK ALL ELECTRICAL FIXTURES PRIOR TO PAINTING.

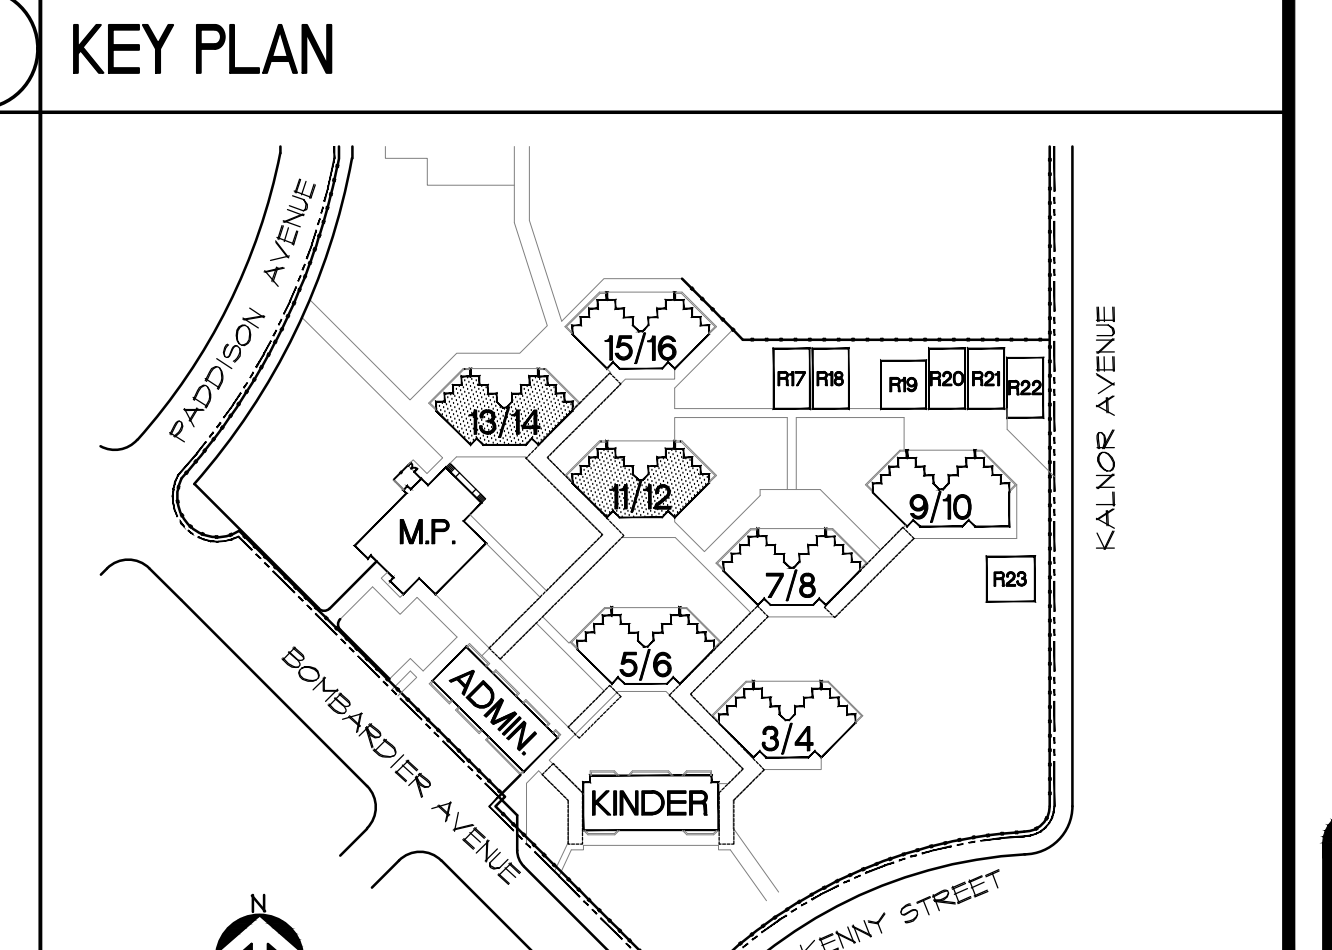

CLASSROOM BUILDING 13/14 - EXTERIOR REFLECTED CEILING PLAN SCALE 1/8" = 1'-0" 6 CLASSROOM BUILDING 11/12 - EXTERIOR REFLECTED CEILING PLAN SCALE 1/8" = 1'-0" 1

CLASSROOM BUILDING 13/14 - NORTH ELEVATION SCALE 1/8" = 1'-0" 7 CLASSROOM BUILDING 11/12 - NORTH ELEVATION SCALE 1/8" = 1'-0" 2

CLASSROOM BUILDING 13/14 - SOUTH ELEVATION SCALE 1/8" = 1'-0" 8 CLASSROOM BUILDING 11/12 - SOUTH ELEVATION SCALE 1/8" = 1'-0" 3

CLASSROOM BUILDING 13/14 - SE ELEV. SCALE 1/8" = 1'-0" 10 CLASSROOM BUILDING 13/14 - SW ELEV. SCALE 1/8" = 1'-0" 9 CLASSROOM BUILDING 11/12 - SE ELEV. SCALE 1/8" = 1'-0" 5 CLASSROOM BUILDING 11/12 - SW ELEV. SCALE 1/8" = 1'-0" 4

DATE: 02/14/20	DESIGNED BY: KC	DATE	BY
JOB NO.: 180104	DRAWN BY: KA	NO.	REVISION
	CHECKED BY: JP		

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**ZIEMBA + PRIETO ARCHITECTS**  
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EXTERIOR REFLECTED CEILING PLANS AND EXTERIOR ELEVATIONS FOR CLASSROOM BUILDINGS 11/12 & 13/14

LITTLE LAKE CITY SCHOOL DISTRICT  
LAKELAND ELEMENTARY SCHOOL  
11224 BOMBARDIER AVENUE  
NORWALK, CALIFORNIA 90650

LICENSED ARCHITECT  
C-33216  
RENEWAL DATE  
NOV. 30, 2024  
STATE OF CALIFORNIA

SHEET NO.  
**A4.3-F**

ORIGINAL DATE: 03/26/16