REPLACEMENT OF PLAYGROUND EQUIPMENT FOR WILLIAM ORR ELEMENTARY SCHOOL

12130 JERSEY AVENUE, NORWALK, CA 90650

LITTLE LAKE CITY SCHOOL DISTRICT

10515 SOUTH PIONEER BOULEVARD, SANTA FE SPRINGS, CA 90670

DESIGN TEAM TELEPHONE FACSMILE **EMAIL ADDRESS** COMPANY jprieto@ziembaprietoarch.com (818) 841-2585 F (818) 841-7782 601 S. GLENOAKS BLVD., SUITE 400, BURBANK, CA 91502 ZIEMBA + PRIETO ARCHITECTS **ARCHITECT** CIVIL ENGINEER SAXON ENGINEERING 2605 TEMPLE HEIGHTS DRIVE SUITE A, OCEANSIDE, CA 92056 (949) 366-2180 F (949) 366-5280 kurts@saxonengr.com SHADE STRUCTURE 1885 NORTH MAIN ST. ORANGE, CA 92865 (714) 279-8383 F (800) 729-2483 DAVE BANG ASSOCIATES, INC. Info@davebang.com **ABBREVIATIONS** MATERIALS LEGEND SYMBOLS ROUGH LUMBER/BLOCKING FOM FOS DRINKING FOUNTAIN AMERICANS WITH FACE OF MASONRY PHYSICALLY DISABLED DISABILITIES ACT PANIC HARDWARE BATT INSULATION WINDOW NO. ABOVE FINISHED FLOOR DIMENSION FIRFPROOF PLANTER 44 44 CONCRETE SECTION OUT NUMBER FONGUE & GROOVE PLUMB PLUMBING RIGID INSULATION ARCHITECT(URAL) DISABLE PERSON(S) FINISH SURFACE PLYWOOD DOOR NO. A PLYWOOD FEET / FOOT THICK(NESS) DIVISION OF THE STATE FTG PATH OF TRAVEL PLASTER TOP OF BEAM BOARD ARCHITECT FIELD VERIFY LABEL PRESSURE TREATED POUNDS DEMOLITION KEYNOTE CERAMIC/ QUARRY TILE TOP OF CONCRETE PRESSURE TREATED BUILDING TOP OF MASONRY GALV/GV GALVANIZED DOUGLAS FIR ELEVATION NUMBER TOP OF PARAPET BLOCKING RECONSTRUCTION PARTICLE BOARD GENERAL CONTRACTOR TOP OF SHEATHING STONE EXPANSION JOINT BOTTOM TOP OF WALL KEYNOTE GALVANIZED IRON BOTTOM OF WALL TYPICAL MATERIA ELECTRICAL GRAVEL/STONE FILL ACOUSTICAL TILE BEARING **LEVATION** GLUE-LAMINATED BEAM MAX ± 0'- 0"
FIN. FLR.

FLOOR ELEVATION MECH MECHANICAL UNLESS NOTED OTHERWISE ELECTRICAL METAL REFERENCE GUARDRAIL MANUFACTURER END NAILING SAND/GRANULAR FILL ALUMINUM CATCH BASIN REQUIRED MULTI-ELEV. BUBBLE VINYL COMPOSITION TILE EVENLY SPACED EACH WAY MISC MISCELLANEOUS CALIFORNIA BUILDING CODE RGBM REINF. GROUTED BRICK MAS CALIFORNIA CODE REGULATION E.W. HEADED ANCHOR ROOF LADDER FINISHED WOOD HEADED ANCHOR STUD MTD VERTICAL GRAIN DOUGLAS FIR **EXTERIOR** REVISION NO. CAST-IRON VERIFY IN FIELD CONTROL JOINT ROUGH OPENING FLOOR DRAIN HOLLOW CORE RESOURCE SPECIALIST FACTORY FINISH HOLLOW META CONCRETE MASONRY UNIT NOT IN CONTRACT MITHOUT FOUNDATION HDR (NOT PART OF THIS WATER CLOSET FIRE EXTINGUISHER HEADER CASED OPENING FINISHED FLOOR ELEVATION HORIZ HORIZONTAL APPLICATION) SCHEDULE **WATERPROOF** FINISHED FLOOR NTS NOT TO SCALE CONCRETE WOOD SCREW CONC BLK CONCRETE BLOCK FINISHED FLOOR LINE SHEATHING CONST CONSTRUCTION CONT CONTINUOUS FINISH GRADE / FIXED GLASS O.C . ON CENTER INSIDE DIAMETER SCOPE OF WORK INDEX OF DRAWINGS **GENERAL NOTES** ARCHITECTS STATEMENT NO. SHT. NO. 13 SHEETS TOTAL Statement of General Conformance THE SCOPE OF WORK CONSISTS OF THE FOLLOWING: INCLUDING BUT NOT LIMITED TO THE ATTACHED UPON AWARD OF CONTRACT, SHELTER CONTRACTOR SHALL SECURE THE CONTRACT DOCUMENTS COMPLETE. TITLE SHEET / GENERAL NOTES 2 SHEETS FOR ARCHITECTS/ENGINEERS WHO UTILIZE PLANS. INCLUDING BUT NOT LIMITED TO SHOP DRAWINGS, PREPARED BY OTHER LICENSED TITLE, DESIGN TEAM, ABBREVIATIONS, SYMBOLS, CODES, VICINITY MAP & INDEX

APPLICABLE CODES

LIST OF 2019 CALIFORNIA CODE OF REGULATIONS (C.C.R.)

2019 CALIFORNIA BUILDING STANDARDS ADMINISTRATIVE CODE, (CAC), PART I, TITLE 24 C.C.R.

(BASED ON 2018 INTERNATIONAL FIRE CODE WITH CALIFORNIA AMENDMENTS) 2019 CALIFORNIA EXISTING BUILDING CODE, (CFC), PART 10, TITLE 24 C.C.R.

(BASED ON 2018 INTERNATIONAL EXISTING BUILDING CODE WITH CAL. AMENDMENT 2019 CALIFORNIA GREEN BUILDING STANDARDS CODE, (CFC), PART II, TITLE 24 C.C.R.

2019 CALIFORNIA REFERENCE STANDARDS, PART 12, TITLE 24 C.C.R. (PARTIAL LIST - SEE CBC CHAPTER 35 AND CFC CHAPTER 45)

TITLE 19 C.C.R. PUBLIC SAFETY, STATE FIRE MARSHAL

APPLICABLE STANDARDS AND GUIDES

2017 EDITION NFPA 17A WET CHEMICAL EXTINGUISHING SYSTEMS 2016 EDITION NFPA 72 NATIONAL FIRE ALARM CODE (CALIFORNIA AMENDED) (NOTE SEE UL STANDARD 1971 FOR "VISUAL DEVICES")

FEDERAL CODES AND STANDARDS:

AMERICANS WITH DISABILITIES ACT (ADA), TITLE II OR TITLE III

TITLE II: UNIFORM FEDERAL ACCESSIBILITY STANDARDS (UFAS) OR ADA STANDARDS FOR

TITLE III: ADA STANDARDS FOR ACCESSIBLE DESIGN (APPENDIX A OF 28 CFR, PART 36

ACCESSIBLE DESIGN (APPENDIX A OF 28 CFR, PART 36).

DESIGN PROFESSIONALS AND/OR CONSULTANTS


(Application No. 03-121266 File No. 19 - 60

 This drawing, page of specifications/calculations have been prepared by other design professionals or consultants who are licensed and/or authorized to prepare such drawings in this state. It has been examined by me for:

■ The drawings or sheets listed on the cover or index sheet C0.0, C1.0, C2.0, C3.0

1) design intent and appears to meet the appropriate requirements of Title 24, California Code of Regulations and the project specifications prepared by me, and 2) coordination with my plans and specifications and is acceptable for incorporation into the construction of this project.

The Statement of General Conformance "shall not be construed as relieving me of my rights, duties, and responsibilities under Sections 17302 and 81138 of the Education Code and Sections 4-336, 4-341 and 4-344" of Title 24, Part 1. (Title 24, Part 1, Section 4-317 [b])

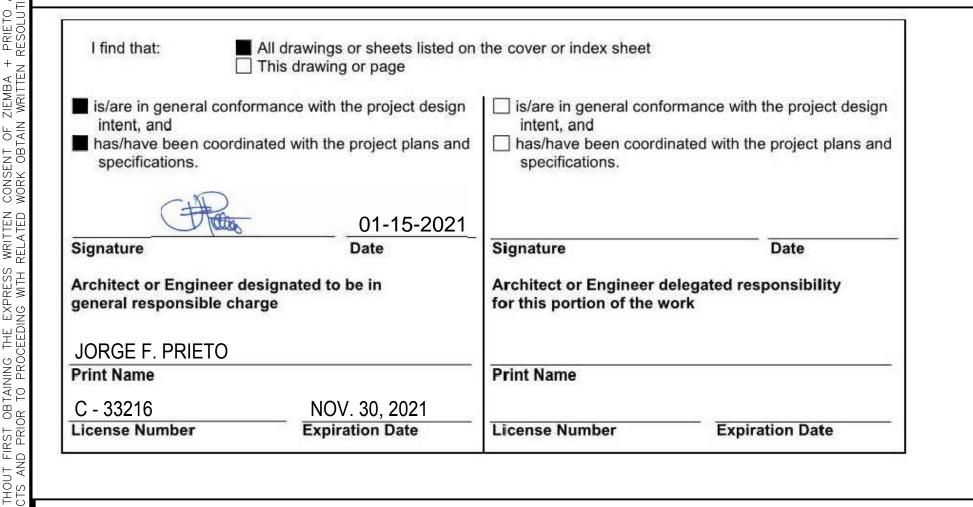

A. <u>PLAYGROUND EQUIPMENT SCOPE OF WORK:</u>

SELECTIVE DEMOLITION OF (E) STRUCTURE, RUBBERIZED SURFACE, SUPPORT AND FOOTINGS. INFILL & COMPACT AS REQUIRED, PREP AREA FOR INSTALLATION OF RUBBERIZED SURFACE & PLAYGROUND EQUIPMENT.

2. PROVIDE / CONSTRUCT PLAYGROUND AND MATTING. PLAYGROUND EQUIPMENT

3. ACCESSIBLE PATH OF TRAVEL EQUIPMENT AND MATTING.

B. NOTE:

PLAYGROUND EQUIPMENT FURNISHED BY DISTRICT AND INSTALLED BY CONTRACTOR.

. RECEIVING MERCHANDISE: CONTRACTOR SHALL VERIFY EQUIPMENT, INSPECT AND UNLOAD EQUIPMENT AND SECURE STORAGE LOCATION. IF DAMAGE IS NOTED, CONTACT THE DISTRICT, PRIOR TO ACCEPTING DELIVERY.

: MINOR ALTERATION TO ADMINISTRATION RESTROOM & BUILDING 800 RESTROOM - GRAB BAR, TOILET PAPER DISPENSER, TOILET SEAT COVER DISPENSER, SOAP DISPENSER, AND PLUMBING LINE RELOCATION (WHERE OCCURS).

PROJECT AREA SO THAT NO UNAUTHORIZED PERSONNEL OR CHILDREN WILL BE NEAR THE BUILDING OR ADJACENT CONSTRUCTION AREA. CONTRACTOR TO FOLLOW PROVISIONS OF PARTS 1 & 2 CALIFORNIA CODE OF T.2 GENERAL NOTES

CONDITIONS OCCUR.

CHECKING AGENCY.

4 SHEETS

6 SHEETS

1 SHEETS

CIVIL

ARCHITECTURAL

PLAY STRUCTURE

C0.0 TITLE SHEET

AS1.0 | SITE PLAN

SITE DETAILS

PS-1 PLAY STRUCTURE EQUIPMENT

AS1.2

DEMOLITION PLAN

PRECISE GRADING PLAN

EROSION CONTROL PLAN

SITE PLAN (FIRE DEPARTMENT)

ENLARGED DEMOLITION SITE PLAN & DETAILS

ENLARGED NEW CONSTRUCTION SITE PLAN & DETAILS

ENLARGED RESTROOM FLOOR PLANS AND INTERIOR ELEVATIONS

REGULATIONS OF TITLE 24. CONTRACTOR TO COMPLY WITH ALL APPLICABLE SAFETY LAWS; OSHA,

CONTRACTOR SHALL PROVIDE DISTRICT WITH A WRITTEN SEQUENCE OF WORK WHICH IS TO BE APPROVED PRIOR TO THE START OF

THE DISTRICT CONTACT IS MR. BRENT GRIFFEN, DIRECTOR OF MAINTENANCE, OPERATIONS AND CUSTODIAL SERVICES. LITTLE LAKE SCHOOL DISTRICT 10515 SOUTH PIONEER BLVD. SANTA FE SPRINGS, CA 90670 TEL: 562-868-8241 X2280 EMAIL BGRIFFEN@LLCSD.NET

THE DISTRICT SHALL PROVIDE THE CONTRACTORS WITH UTILITIES (ELECTRICITY AND WATER) FOR THEIR PORTION OF THE WORK.

CONTRACTOR SHALL BE SOLELY RESPONSIBLE FOR SECURING HIS EQUIPMENT SUPPLIES, TOOLS, ETC. DETAILS MARKED TYPICAL ON DRAWINGS ARE INTENDED TO SHOW TYPICAL CONDITIONS FOR THE ENTIRE PROJECT AND ARE TO APPLY WHERE SIMILAR

ALL EXISTING DIMENSIONS SHALL BE VERIFIED BY THE CONTRACTORS IN THE FIELD. ANY DISCREPANCIES SHALL BE BROUGHT TO THE ATTENTION OF THE ARCHITECT PRIOR TO CONSTRUCTION. SHOULD ANY CONDITION DEVELOP NOT COVERED BY THE CONTRACT DOCUMENTS WHEREIN THE FINISHED WORK WILL NOT COMPLY WITH TITLE 24, CCR, A CHANGE ORDER DETAILING AND SPECIFYING THE REQUIRED WORK WILL BE SUBMITTED TO

AT CONCLUSION OF HIS OPERATIONS, THE CONTRACTOR SHALL LEAVE THE SITE CLEAN TO THE SATISFACTION OF THE DISTRICT.

3. ALL DEBRIS REMOVED DUE TO NEW WORK BEING ACCOMPLISHED SHALL BE

ASTM DESIGNATIONS TO BE OF LATEST DATE ACCEPTABLE TO THE

ALL MATERIALS USED ON THIS PROJECT ARE ASBESTOS FREE.

AND APPROVED BY THE DIVISION OF THE STATE ARCHITECT BEFORE

MANUFACTURER TO COORDINATE PAINT COLORS WITH OWNER.

6. PROJECT INSPECTOR (PI) CLASSIFICATION FOR THIS PROJECT IS: CLASS II CHANGES TO THE APPROVED DRAWINGS AND SPECIFICATIONS SHALL BE MADE BY AN ADDENDUM OR A CONSTRUCTION CHANGE DOCUMENT (CCD) APPROVED BY THE DIVISION OF THE STATE ARCHITECT AS REQUIRED BY SECTION 4-338, PART I, TITLE 24, CCR. 8. A DSA CERTIFIED PROJECT INSPECTOR EMPLOYED BY THE DISTRICT

(OWNER) AND APPROVED BY THE DIVISION OF THE STATE ARCHITECT SHALL PROVIDE CONTINUOUS INSPECTION OF THE WORK, THE DUTIES OF THE INSPECTOR ARE DEFINED IN SECTION 4 - 342, PART I, TITLE 24, CCR.

19. REFER TO CONTRACT DOCUMENTS FOR REMAINDER OF WORK.


20. A DSA ACCEPTED TESTING LABORATORY DIRECTLY EMPLOYED BY THE DISTRICT (OWNER) SHALL CONDUCT ALL THE REQUIRED TESTS AND INSPECTIONS FOR THE

GENERAL NOTES CONT.

THE INTENT OF THESE DRAWINGS AND SPECIFICATIONS IS THAT THE WORK OF THE ALTERATION, REHABILITATION OR RECONSTRUCTION IS TO BE IN ACCORDANCE WITH TITLE 24, CCR. SHOULD ANY EXISTING CONDITIONS SUCH AS DETERIORATION OR NON-COMPLYING CONSTRUCTION BE DISCOVERED WHICH IS NOT COVERED BY THE CONTRACT DOCUMENTS WHEREIN THE FINISHED WORK WILL NOT COMPLY WITH TITLE 24, CCR, A CONSTRUCTION CHANGE DOCUMENT (CCD), OR A SEPARATE SET OF PLANS AND SPECIFICATIONS, DETAILING AND SPECIFYING THE REQUIRED WORK SHALL BE SUBMITTED TO AND APPROVED BY DSA BEFORE PROCEEDING WITH THE WORK. (SECTION 4-317(C), PART I, TITLE

22. GRADING PLANS, DRAINAGE IMPROVEMENTS, ROAD AND ACCESS REQUIREMENTS AND ENVIRONMENTAL HEALTH CONSIDERATIONS SHALL COMPLY WITH ALL LOCAL ORDINANCES.

VICINITY MAP

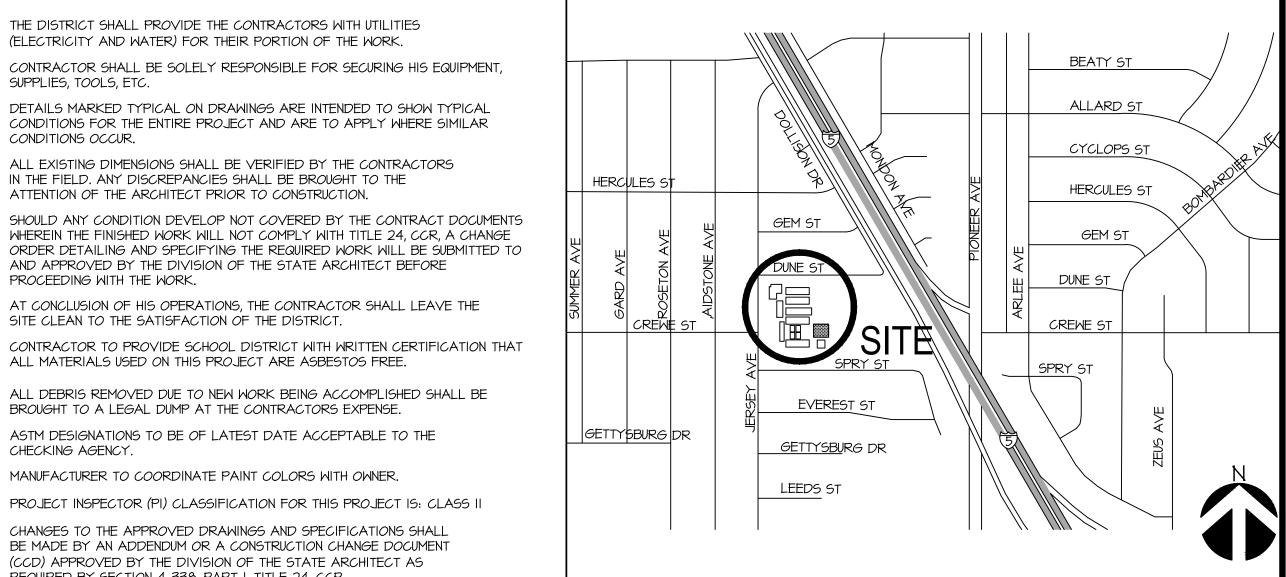

DSA/F.I.R.M. INFORMATION

PROJECT TRACKING # 64717-45

F.I.R.M. DATA: FLOOD ZONE X FLOOD PLANE PANEL NUMBER 1837 of 2350 MAP NUMBER 06037C1837F MAP EFFECTIVE DATE: SEP. 26, 2008 NO. DATE





SHEET NO.

TYPICAL GENERAL NOTES - (CONT.)	TYPICAL GENERAL NOTES
49. PRECAUTIONS TO BE TAKEN BY THE CONTRACTOR TO NOT DAMAGE EXISTING ASPHALT OR CONCRETE PAVING SCHEDULED TO REMAIN. DAMAGED CONCRETE PAVING SHALL BE CUT BACK TO THE NEAREST SCORE JOINT. INSTALL NEW CONCRETE PAVING/PATCHING AS REQUIRED ON DRAWINGS. DOWEL NEW SLAB TO EXISTING SLAB. A.C. PAVING DAMAGED DURING CONSTRUCTION	I. THE DRAWINGS INDICATE THE END RESULT. IT SHALL BE THE CONTRACTOR'S RESPONSIBILITY TO VISIT THE JOB SITE PRIOR TO BID SUBMITTAL TO DETERMINE ANY PROBLEMS HE WILL HAVE IN PERFORMING THE WORK. THE BID SHALL INCLUDE THE COST OF THE RESOLUTION OF ALL PROBLEMS.
SHALL BE PATCHED AS REQUIRED FOR LEVEL TRANSITION. 50. IT IS THE CONTRACTOR'S RESPONSIBILITY TO PROTECT THE SITE ONCE HE IS GIVEN THE NOTICE TO PROCEED. ANY DAMAGE OR THEFT TO THE SITE AND/OR BUILDINGS IS THE SOLE RESPONSIBILITY OR THE CONTRACTOR.	2. EXISTING RECORD DRAWINGS (NOT NECESSARILY CORRECT OR UP-TO-DATE) MAY BE INSPECTED AT THE OWNER'S OFFICE. PRIOR ARRANGEMENTS WITH THE OWNER WILL BE REQUIRED.
51. THE INTENT OF THIS DRAWINGS AND SPECIFICATIONS IS THAT THE WORK ALTERATION, REHABILITATION OR RECONSTRUCTION IS TO BE IN ACCORDANCE WITH TITLE 24, CCR, SHOULD ANY EXISTING CONDITIONS SUCH AS DETERIORATION OR NON-COMPLYING CONSTRUCTION BE DISCOVERED WHICH IS NOT COVERED BY THE CONTRACT DOCUMENTS WHEREIN THE FINISHED WORK WILL NOT COMPLY WITH THE TITLE 24, CCR, A CONSTRUCTION CHANGE DOCUMENT (CCD), OR A SEPARATE SET OF PLANS AND SPECIFICATIONS, DETAILING AND SPECIFYING THE REQUIRED WORK SHALL BE SUBMITTED TO AND APPROVED BY DSA BEFORE PROCEEDING WITH THE WORK. (SECTION 4-317(c), PART I, TITLE 24, CCR).	 ALL WORK SHALL CONFORM TO THE REQUIREMENTS OF THE LATEST EDITION OF THE CALIFORNIA BUILDING CODE. COMPLIANCE WITH ADDITIONAL NOTED STANDARDS, SHALL BE TO THE MOST RECENTLY ACCEPTED/PUBLISHED STANDARDS, AS APPROVED BY THE GOVERNING AGENCY. CONTRACTOR SHALL REMAIN SOLELY RESPONSIBLE FOR INSTALLING/MAINTAINING ADEQUATE BRACING DURING CONSTRUCTION UNTIL THE STRUCTURE IS SUFFICIENTLY COMPLETE TO PROVIDE SUPPORT FOR THE VARIOUS INDIVIDUAL ELEMENTS AS INTENDED IN THE FINISHED STRUCTURE. DETAILS MARKED TYPICAL ON DRAWINGS ARE INTENDED FOR TYPICAL CONDITIONS ON THE ENTIRE PROJECT AND ARE TO APPLY WHERE SIMILAR CONDITIONS OCCUR.
52. GRADING PLANS, DRAINAGE IMPROVEMENTS, ROAD AND ACCESS REQUIREMENTS AND ENVIRONMENTAL HEALTH CONSIDERATIONS SHALL COMPLY WITH ALL LOCAL ORDINANCES.	 ALL ITEMS ARE NEW UNLESS NOTED AS EXISTING - TYPICAL. OCCUPANTS OF THE SITE SHALL BE SPARED INCONVENIENCE, DUE TO THE CONTRACTOR'S WORK, DEBRIS, ETC. THE OWNER SHALL BE NOTIFIED, IN ADVANCE, OF TIMES OF DELIVERY OF EQUIPMENT IN ORDER TO AVOID INTERFERENCE WITH THE NORMAL ACTIVITY OF THE SITE. UPON CONCLUSION OF PROJECT, CONTRACTOR SHALL PROVIDE OWNER WITH WRITTEN
	GERTIFICATION THAT ALL MATERIALS USED ON THIS PROJECT ARE ASBESTOS FREE. 9. UPON CONCLUSION OF PROJECT, CONTRACTOR SHALL PROVIDE OWNER WITH MANUFACTURER'S SAFETY DATA SHEETS (MSDS) FOR ALL HAZARDOUS MATERIALS TO BE BROUGHT ON SITE TO PERFORM WORK UNDER THIS CONTRACT.
	 IF DURING DEMOLITION, NEW CONSTRUCTION, ETC., ANY EXISTING UTILITY LINES ARE ENCOUNTERED, THEY MUST BE RELOCATED AS REQUIRED TO ACCOMPLISH NECESSARY ALTERATIONS AND/OR AS DIRECTED BY THE ARCHITECT AT NO ADDITIONAL COST TO THE OWNER. II. THESE DRAWINGS WERE PREPARED IN A MANNER CONSISTENT WITH EXISTING PROFESSIONAL STANDARDS AND WITH THE UNDERSTANDING THAT THESE DRAWINGS WOULD BE USED SOLELY BY QUALIFIED AND EXPERIENCED CONSTRUCTION AND/OR DESIGN PROFESSIONALS FOR USE IN THE CONSTRUCTION OF THIS SPECIFIC PROJECT ONLY. THE DETAILS INDICATED ON THESE PLANS REPRESENT GENERAL TYPICAL DETAILS REQUIRED FOR COMMUNICATING THIS PROJECT'S DESIGN
	INTENT TO SUCH QUALIFIED CONSTRUCTION PROFESSIONALS AND AS SUCH MAY NOT INCLUDE ALL THE DETAILS NECESSARY FOR THE FINAL COMPLETION OF THIS PROJECT. 12. FIRE SAFETY DURING DEMOLITION & CONSTRUCTION SHALL COMPLY W/ CFC CHAP. 33
	 I3. WHEN ITEMS ARE REMOVED FROM WALLS THAT ARE REMAINING, WALL SURFACES SHALL BE FINISHED TO GIVE A UNIFORM SURFACE. MATCH EXISTING MATERIALS, COLOR AND TEXTURE, U.N.O. I4. IT SHALL BE THE SOLE RESPONSIBILITY OF THE CONTRACTOR TO REVIEW PLANS & SPECS, AND COORDINATE THE WORK PRIOR TO THE COMMENCEMENT OF ANY PORTION OF THE WORK. I5. ALL DRAWINGS, NOTES, SYMBOLS, ETC. WITHIN THE CONTRACT DOCUMENT SET ARE INTENDED TO CONVEY THE DESIGN INTENT. NO DRAWING, NOTE, SYMBOL, ETC. SHALL SUPERSEDE ANOTHER. ALL CONFLICTS THAT ARISE SHALL BE REPORTED IN WRITING TO THE ARCHITECT FOR CLARIFICATION/RESOLUTION WITHIN THE DESIGN INTENT.
	 I6. DO NOT SCALE DRAWINGS. CONTRACTOR SHALL VERIFY ALL DIMENSIONS AND EXISTING SITE CONDITIONS. IF DISCREPANCIES ARE FOUND, THE ARCHITECT SHALL BE NOTIFIED IMMEDIATELY FOR CLARIFICATION. I7. REFERENCING OF DRAWINGS IS FOR CONVENIENCE ONLY AND DOES NOT LIMIT APPLICATION OF ANY DRAWING OR DETAIL. I8. ALL DIMENSIONS ARE TO BE FILED VERIFIED BY CONTRACTOR.
	 19. A DSA ACCEPTED TESTING LABORATORY DIRECTLY EMPLOYED BY THE SCHOOL DISTRICT SHALL CONDUCT ALL THE REQUIRED TESTS AND INSPECTIONS FOR THE PROJECT. 20. AS ARCHITECT OF RECORD, THE ARCHITECT RETAINS THE RIGHT TO MAKE FINAL JUDGMENTS RELATIVE TO MODIFICATIONS OF THE SUBMITTAL DRAWINGS TO ENSURE COMPLIANCE OF THE DOCUMENTS WITH STANDARD ENGINEERING PRACTICE, APPLICABLE CODES, AND ARCHITECTURAL INTENT.
	21. ALL WORK SHALL CONFORM TO 2019 EDITION TITLE 24 & TITLE 19, CALIFORNIA CODE OF REGULATIONS (CCR). 22. WHEN A REFERENCE IS MADE, BEGINNING WITH THE PHRASE "SEE" OR "REFER TO", THE
	CONTRACTOR SHALL PERFORM ADDITIONAL WORK AS OUTLINED IN THE REFERENCED LOCATION, AS NOTED THERE, IN ADDITION TO THE WORK NOTED IN THE ORIGINAL LOCATION. 23. THE CONTRACTOR SHALL INFORM THE ARCHITECT OF ANY CONFLICTS PRIOR TO PROCEEDING WITH
	CONSTRUCTION. 24. THE CONTRACTOR SHALL BE RESPONSIBLE FOR ALL CUTTING, FITTING OR PATCHING THAT MAY BE REQUIRED TO COMPLETE THE WORK OR TO MAKE ITS SEVERAL PARTS FIT TOGETHER PROPERLY. 25. THE DISTRICT PROJECT MANAGER IS TO BE INFORMED OF CONSTRUCTION SCHEDULES ON A WEEKLY BASIS AND NOTIFIED IMMEDIATELY OF ANY PROPOSED CHANGES.
	 26. UNLESS SHOWN OTHERWISE, ALL DAMAGE CAUSED BY NEW WORK TO EXISTING AREAS OF THE SITE SHALL BE PATCHED TO MATCH EXISTING CONDITIONS OR AS FOUND PRIOR TO ANY DAMAGE. 27. THE CONTRACTOR SHALL BE RESPONSIBLE FOR THE PROTECTION OF ALL EXISTING STRUCTURES AT THE WORK AREA FROM WEATHER AND OTHER INCLEMENT CONDITIONS. ANY DAMAGE INCURRED DUE TO FAILURE BY THE CONTRACTOR TO PROPERLY PROTECT SUCH WORK SHALL BE REPAIRED AT CONTRACTOR'S EXPENSE. 28. CONTRACTOR SHALL BE SOLELY RESPONSIBLE FOR SECURING HIS EQUIPMENT, SUPPLIES, TOOLS, ETC.
	29. CONTRACTOR TO SUBMIT SHOP DRAWINGS FOR ALL NEW MATERIALS TO THE ARCHITECT FOR REVIEW PRIOR TO FABRICATION OR INSTALLATION.
	30. WHEN CONTRACTOR HAS BEEN AWARDED THE CONTRACT, IT IS HIS RESPONSIBILITY TO SECURE THE AREAS SO NO UNAUTHORIZED PERSONNEL OR CHILDREN GAIN ACCESS TO THE PROJECT AREA OR THE CONTRACTOR'S STAGING AREA.
	 31. THE CONTRACTOR SHALL COOPERATE WITH THE OWNER TO THE FULLEST EXTENT IN PROVIDING TRAFFIC CONTROL DURING COURSE OF CONSTRUCTION SO AS TO PROVIDE A MAXIMUM PROTECTION FOR STUDENTS AND DISTRICT PERSONNEL. ALL EMPLOYEES ON THE PROJECT WORK SHALL PARK THEIR PRIVATE VEHICLES IN THE AREA DESIGNATED BY THE OWNER. 32. THE CONTRACTOR SHALL EXERCISE MAXIMUM DUST AND NOISE CONTROL EFFORTS TO KEEP AT A MINIMUM THE NUISANCE OF DUST AND CONSTRUCTION NOISE FROM THE CONSTRUCTION. 33. THE OWNER SHALL BE NOTIFIED, IN ADVANCE, OF TIMES OF EQUIPMENT OR MATERIALS DELIVERY
	IN ORDER TO AVOID INTERFERENCE WITH THE NORMAL ACTIVITY ON THE SCHOOL PREMISES. 34. CONTRACTOR TO SECURE ALL DOOR OPENINGS TO PROTECT AGAINST THEFT OF ROOM CONTENTS. 35. WORKERS ARE ONLY ALLOWED IN AREAS THAT ARE ONLY APPROPRIATE TO THE REQUIRED WORK AND SHALL MAKE EVERY EFFORT NOT TO DISTURB STUDENTS OR FACULTY. 36. ALL WORKERS SHALL WEAR APPROPRIATE SAFETY GEAR AND COMPLY WITH APPLICABLE
	SAFETY REGULATIONS. 37. DRESS AND BEHAVIOR OF ALL CONSTRUCTION WORKERS SHALL BE APPROPRIATE TO A SCHOOL SITE AND BE ACCEPTABLE TO DISTRICT REPRESENTATIVES.
	38. SMOKING SHALL NOT BE ALLOWED ON CAMPUS DURING THE ENTIRE CONSTRUCTION PROCESS. 39. THERE SHALL BE NO POSSESSION OR CONSUMPTION OF DRUGS OR ALCOHOLIC BEVERAGES ON THE JOB SITE BY ANY PERSON. ANY PERSON THAT DOES NOT COMPLY WITH THESE REQUIREMENTS SHALL BE DIRECTED TO LEAVE THE JOB SITE AND WILL NOT BE PERMITTED TO RETURN DURING THE REMAINDER OF THE CONTRACT.
	 40. THE CONTRACTOR SHALL PROVIDE WHATEVER MEANS NECESSARY TO ASSURE PROTECTION OF STUDENTS AND FACULTY DURING THE COURSE OF CONSTRUCTION OPERATIONS. 41. ALL DIMENSIONS SHOWN ARE FOR ESTIMATING PURPOSES ONLY. CONTRACTORS WILL BE REQUIRED, PRIOR TO BID, TO VERIFY ALL DIMENSIONS AND AREAS TO RECEIVE DEMO. OF EXISTING MATERIALS AND INSTALLATION OF NEW DOORS, FRAMES, AND PAVING. ANY DISCREPANCIES BETWEEN EXISTING CONDITIONS AND THESE PLANS SHALL BE BROUGHT TO THE ATTENTION OF THE ARCHITECT PRIOR TO BID.
	 42. CONTRACTOR TO VERIFY ALL DIMENSIONS AND LOCATIONS OF EXISTING CONDITIONS ON THE JOB SITE PRIOR TO THE START OF WORK OF PORTIONS OF THE WORK. NOTIFY THE ARCHITECT IMMEDIATELY OF ANY DISCREPANCIES BETWEEN ACTUAL FIELD CONDITIONS AND CONSTRUCTION DOCUMENTS. EXISTING CONDITIONS ARE INDICATED AS A RESULT OF INFORMATION SHOWN ON AVAILABLE DOCUMENTS. ANY DAMAGE TO EXISTING CONDITIONS IS THE SOLE RESPONSIBILITY OF THE CONTRACTOR. 43. WHERE ANY CONFLICT OCCURS BETWEEN THE REQUIREMENTS OF FEDERAL, STATE AND LOCAL
	LAWS, CODES, ORDINANCES, RULES AND REGULATIONS, THE MOST STRINGENT SHALL GOVERN. 44. OCCUPATIONAL SAFETY AND HEALTH, THESE DOCUMENTS, AND THE CONSTRUCTION HEREBY CONTEMPLATED, IS TO BE GOVERNED AT ALL TIMES BY APPLICABLE PROVISIONS OF THE CALIFORNIA OCCUPATIONAL SAFETY AND HEALTH ACT OF 1973, (CAL/OSHA) AND ALL UPDATES SINCE.
	 45. COMPLY WITH CFC CHAPTER 14 FOR FIRE SAFETY DURING CONSTRUCTION. 46. DETAILS MARKED "TYPICAL" SHALL APPLY IN ALL CASES UNLESS SPECIFICALLY INDICATED OTHERWISE.
	 47. CONTRACTOR TO COORDINATE BETWEEN THE REQUIREMENTS OF THE DRAWINGS AND SPECIFICATIONS. 48. ALL FILL IMPORTED TO THIS SITE MUST BE TESTED FOR TOXIC SUBSTANCES. IT SHALL BE TESTED BY AN INDEPENDENT TESTING LABORATORY AND CERTIFIED THAT IT MEETS ALL STATE, LOCAL AND NATIONAL REGULATIONS AND LAWS. THE CONTRACTOR SHALL PAY FOR THIS TESTING AND

PICAL GENERAL NOTES TYPICAL DEMOLITION NOTES

- BID SUBMITTAL TO DETERMINE ANY PROBLEMS HE WILL HAVE IN BID SHALL INCLUDE THE COST OF THE RESOLUTION OF ALL
- (NOT NECESSARILY CORRECT OR UP-TO-DATE) MAY BE INSPECTED OR ARRANGEMENTS WITH THE OWNER WILL BE REQUIRED.
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- ROM WALLS THAT ARE REMAINING, WALL SURFACES SHALL BE SURFACE. MATCH EXISTING MATERIALS, COLOR AND TEXTURE, U.N.O.
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- GER IS TO BE INFORMED OF CONSTRUCTION SCHEDULES ON A WEEKLY TELY OF ANY PROPOSED CHANGES.
- DAMAGE CAUSED BY NEW WORK TO EXISTING AREAS OF THE SITE EXISTING CONDITIONS OR AS FOUND PRIOR TO ANY DAMAGE.
- ESPONSIBLE FOR THE PROTECTION OF ALL EXISTING STRUCTURES ATHER AND OTHER INCLEMENT CONDITIONS. ANY DAMAGE INCURRED RACTOR TO PROPERLY PROTECT SUCH WORK SHALL BE REPAIRED
- LY RESPONSIBLE FOR SECURING HIS EQUIPMENT, SUPPLIES, TOOLS,
- DRAWINGS FOR ALL NEW MATERIALS TO THE ARCHITECT FOR N OR INSTALLATION.
- AWARDED THE CONTRACT, IT IS HIS RESPONSIBILITY TO SECURE THE PERSONNEL OR CHILDREN GAIN ACCESS TO THE PROJECT AREA OR
- PERATE WITH THE OWNER TO THE FULLEST EXTENT IN PROVIDING URSE OF CONSTRUCTION SO AS TO PROVIDE A MAXIMUM ND DISTRICT PERSONNEL. ALL EMPLOYEES ON THE PROJECT WORK EHICLES IN THE AREA DESIGNATED BY THE OWNER.
- CISE MAXIMUM DUST AND NOISE CONTROL EFFORTS TO KEEP AT A AND CONSTRUCTION NOISE FROM THE CONSTRUCTION.
- , IN ADVANCE, OF TIMES OF EQUIPMENT OR MATERIALS DELIVERY RENCE WITH THE NORMAL ACTIVITY ON THE SCHOOL PREMISES.
- DOOR OPENINGS TO PROTECT AGAINST THEFT OF ROOM CONTENTS.
- O IN AREAS THAT ARE ONLY APPROPRIATE TO THE REQUIRED EFFORT NOT TO DISTURB STUDENTS OR FACULTY.
- PPROPRIATE SAFETY GEAR AND COMPLY WITH APPLICABLE
- . CONSTRUCTION WORKERS SHALL BE APPROPRIATE TO A SCHOOL DISTRICT REPRESENTATIVES.
- WED ON CAMPUS DURING THE ENTIRE CONSTRUCTION PROCESS. ON OR CONSUMPTION OF DRUGS OR ALCOHOLIC BEVERAGES ON ANY PERSON THAT DOES NOT COMPLY WITH THESE REQUIREMENTS E THE JOB SITE AND WILL NOT BE PERMITTED TO RETURN DURING
- VIDE WHATEVER MEANS NECESSARY TO ASSURE PROTECTION OF S THE COURSE OF CONSTRUCTION OPERATIONS.
- FOR ESTIMATING PURPOSES ONLY. CONTRACTORS WILL BE VERIFY ALL DIMENSIONS AND AREAS TO RECEIVE DEMO. OF TALLATION OF NEW DOORS, FRAMES, AND PAVING. ANY TING CONDITIONS AND THESE PLANS SHALL BE BROUGHT TO THE PRIOR TO BID.
- DIMENSIONS AND LOCATIONS OF EXISTING CONDITIONS ON THE JOB WORK OF PORTIONS OF THE WORK. NOTIFY THE ARCHITECT PANCIES BETWEEN ACTUAL FIELD CONDITIONS AND CONSTRUCTION IONS ARE INDICATED AS A RESULT OF INFORMATION SHOWN ON DAMAGE TO EXISTING CONDITIONS IS THE SOLE RESPONSIBILITY OF
- BETWEEN THE REQUIREMENTS OF FEDERAL, STATE AND LOCAL RULES AND REGULATIONS, THE MOST STRINGENT SHALL GOVERN.
- EALTH, THESE DOCUMENTS, AND THE CONSTRUCTION HEREBY ERNED AT ALL TIMES BY APPLICABLE PROVISIONS OF THE SAFETY AND HEALTH ACT OF 1973, (CAL/OSHA) AND ALL UPDATES
- 4 FOR FIRE SAFETY DURING CONSTRUCTION.
- SHALL APPLY IN ALL CASES UNLESS SPECIFICALLY INDICATED
- E BETWEEN THE REQUIREMENTS OF THE DRAWINGS AND
- ITE MUST BE TESTED FOR TOXIC SUBSTANCES. IT SHALL BE TESTED BY AN INDEPENDENT TESTING LABORATORY AND CERTIFIED THAT IT MEETS ALL STATE, LOCAL AND NATIONAL REGULATIONS AND LAWS. THE CONTRACTOR SHALL PAY FOR THIS TESTING AND PROVIDE A WRITTEN CERTIFICATION TO THE OWNER THAT MATERIALS MEET THESE STANDARDS PRIOR TO BRINGING FILL MATERIALS TO THE SITE.

- DEMOLITION WORK SHOWN ON THE DRAWINGS IS DIAGRAMMATIC. ALL CONDITIONS MAY NOT BE SHOWN. IT IS THE CONTRACTOR'S RESPONSIBILITY TO REMOVE ALL ITEMS THAT WILL INTERFERE WITH NEW CONSTRUCTION.
- 2. ITEMS WHICH ARE SHOWN TO BE REMOVED MAY HAVE BEEN REMOVED PRIOR TO THE START OF CONSTRUCTION. CONTRACTOR SHALL GIVE CREDIT TO THE OWNER FOR THE REMOVAL COST OF
- 3. IF ANY UNKNOWN ASBESTOS OR LEAD PAINT CONTAINING MATERIALS ARE ENCOUNTERED DURING CONSTRUCTION, THE SCHOOL DISTRICT SHALL BE NOTIFIED IMMEDIATELY AND WORK SHALL BE STOPPED AT THOSE AREAS UNTIL THE DISTRICT GIVES THE CONTRACTOR WRITTEN NOTICE TO PROCEED. ASBESTOS AND LEAD PAINT ABATEMENT IS UNDER THIS CONTRACT, SEE DISTRICT ABATEMENT REPORT PREPARED BY DISTRICT CONSULTANT. LEAD AND ASBESTOS ABATEMENT IS
- 4. THE CONTRACTOR SHALL BE RESPONSIBLE FOR COORDINATING ALL WORK WITH THE RECOMMENDATIONS MADE IN THE ASBESTOS AND LEAD PAINT ABATEMENT REPORT.

NOT THE RESPONSIBILITY OF THE ARCHITECT.


6. REFER TO ALL DRAWINGS FOR DEMOLITION WORK.

UNLESS OTHERWISE NOTED.

- WHEN ITEMS ARE REMOVED FROM WALLS THAT ARE TO REMAIN, WALL SURFACES SHALL BE FINISHED TO GIVE A UNIFORM SURFACE. MATCH EXISTING MATERIALS, COLOR AND TEXTURE U.N.O.
- 7. THE CONTRACTOR SHALL PROVIDE A SECURED STAGING AREA (THE LOCATION OF WHICH SHALL BE APPROVED BY THE DISTRICT). RESTORE STORAGE AREA TO ORIGINAL CONDITION UPON COMPLETION OF PROJECT.
- 8. IF DURING DEMOLITION, AND/OR NEW CONSTRUCTION, CONDUITS, PIPING, HIGH / LOW VOLTAGE CABLES, AND/OR TELEPHONE WIRES ARE ENCOUNTERED, THEY MUST BE REMOVED AND RELOCATED AS REQUIRED TO OBTAIN THE DESIRED END PRODUCT AT NO ADDITIONAL COST TO THE SCHOOL DISTRICT. ITEMS THAT HAVE AN IMPACT ON THE AESTHETIC VALUE OF STRUCTURE MUST BE BROUGHT TO THE ATTENTION OF THE ARCHITECT FOR DIRECTION AND COURSE OF ACTION TO
- 9. IT IS THE CONTRACTORS PHYSICAL AND FISCAL RESPONSIBILITY TO DISPOSE OF ALL MATERIALS TO BE REMOVED. HE SHALL DELIVER TO AND DISPOSE OF THEM AT A LEGAL DUMP SITE.
- IO. THE DISTRICT HAS THE FIRST RIGHT TO KEEP WHATEVER MATERIALS ARE TO BE DEMOLISHED. CONTRACTOR SHALL COORDINATE DEMOLITION WITH THE DISTRICT.
- . ALL EXISTING ITEMS TO BE REMOVED, STORED, AND REINSTALLED SHALL BE DONE IN A CAREFUL MANNER, CONTRACTOR SHALL BE RESPONSIBLE TO REPLACE ANY DAMAGE IN KIND AT NO ADDITIONAL COST TO OWNER. CONTRACTOR SHALL HAVE A WRITTEN LOG OF
- 12. ALL DEMOLITION, REINSTALLATION AND RECONSTRUCTION WORK IS BY THE CONTRACTOR
- 13. EXISTING UTILITY LINES WHICH ARE ACTIVE UNDER EXISTING PAVING TO BE REMOVED SHALL BE VERIFIED WITH THE MAINTENANCE DEPARTMENT AND DISTRICT RECORD DRAWINGS.

ALL ITEMS STORED. A SIGNED COPY OF THE LOG SHALL BE GIVEN TO THE OWNER.

- 14. SEE PLANS AND SPECIFICATIONS FOR SCOPE OF WORK IN ADDITION TO WHAT IS MENTIONED
- 15. DURING DEMOLITION AND / OR INSTALLATIONS, IF UTILITY LINES ARE ENCOUNTERED, IT IS THE CONTRACTOR'S RESPONSIBILITY TO ALTER AND RELOCATE EXISTING UTILITIES AS REQUIRED SO ALL UTILITIES CAN FUNCTION PROPERLY.
- 16. UNLESS SPECIFICALLY SHOWN ON THESE PLANS, NO STRUCTURAL MEMBER SHALL BE CUT, DRILLED, NOR NOTCHED WITHOUT PRIOR WRITTEN AUTHORIZATION FROM THE ARCHITECT AND THE DIVISION OF THE STATE ARCHITECT.
- 17. FOR THE REMOVAL OF ALL CONCRETE AND/OR PAVING, CONTRACTOR SHALL SAWCUT ALL BOUNDARY EDGES IN A STRAIGHT AND TRUE MANNER. REMOVAL OF CONCRETE PAVING SHALL BE TO EXISTING SCORE OR EXPANSION JOINTS, OR AS INDICATED ON DRAWINGS.
- 18. THE PROVISIONS OF CBC AND CFC CHAFTER 33 SHALL BE ENFORCED ON THIS PROJECT.

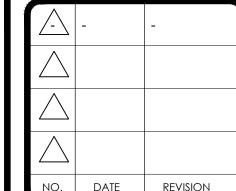

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- CONSTRUCT OFFSITE WORK TO COMPLY WITH THE REQUIREMENTS OF THE LOCAL GOVERNING AGENCY. SECURE AND PAY FOR REQUIRED CONSTRUCTION PERMITS.
- CONSTRUCT STRAIGHT GRADES BETWEEN ELEVATIONS SHOWN ON THE PLANS UNLESS INTERRUPTED BY A GRADE CHANGE LINE. ANY DEVIATION FROM THE GRADING PLAN MUST HAVE PRIOR APPROVAL FROM THE ENGINEER.
- GRADE LAWN, TURF, PLANTING AND AGRICULTURAL AREA $1\frac{1}{2}$ " BELOW DESIGN GRADES INDICATED.
- REMOVE YARD BOXES WITHIN THE GRADING LIMITS AND INSTALL NEW ONES TO MATCH DESIGN GRADES PER DETAIL. VERIFY LOCATION AND NUMBER OF YARD BOXES IN THE FIELD PRIOR TO
- ADJUST TO DESIGN GRADE TOP OF EXISTING VALVE BOXES WITHIN AREAS TO BE REGRADED.
- TRIM TREE ROOTS AS NECESSARY TO CONSTRUCT PAVEMENT AND INSTALL HEADERS. TRIM ROOTS UNDER THE DIRECTION OF A CERTIFIED ARBORIST. NOTIFY DISTRICT GARDENING SUPERVISOR PRIOR TO TRIMMING OF TREES. PROVIDE NEW TREE IF DAMAGED.
- WHERE NEW PAVEMENT OR CURB IS TO BE CONSTRUCTED UNDER A FENCE, UNITE AND REMOVE FENCE FABRIC TO PERMIT CONSTRUCTION. AFTER CONSTRUCTION, ADD OR CUT AND KNUCKLE FABRIC TO FIT NEW SURFACE AND RE-INSTALL. ADJUST, MODIFY OR REPLACE GATES, IF ANY, TO CLEAR NEW GRADES. CLEARANCE SHOULD NOT EXCEED 1.5" ABOVE SURFACE AT THE GATE OPENING.
- PROVIDE AND INSTALL 2"X6" REDWOOD HEADERS AT NEW A.C. PAVEMENT PER DETAIL AT THE FOLLOWING LOCATIONS UNLESS NOTED OTHERWISE * AT TREE AREAS, TREE WELLS SHALL BE 10'X10' FOR TREES WITH 12" DIAMETER OR GREATER TRUNK SIZE, 8'X8' FOR TREES LESS THAN 12" DIAMETER AND FOR NEW TREES, SEE LANDSCAPED
 - * WHERE IT ABUTS LAWNS, TURFS, PLANTING AREAS, OTHER UNPAVED AREAS AND EXISTING WOOD STRUCTURES.
- PROVIDE AND INSTALL 2"X6" REDWOOD HEADERS SIMILAR TO DETAIL 10 AT SAWCUT EDGES OF A.C. PAVEMENT ADJOINING NEW PLANTING OR TREE AREAS.
-). PLAYGROUND EQUIPMENT ARE TO REMAIN UNLESS PLAYGROUND COURT MARKING PLAN INDICATES
- PLAYGROUND COURT MARKINGS AND EQUIPMENT SHALL CONFORM TO DISTRICT STANDARDS.
- PLAYGROUND EQUIPMENT ARE TO BE INSTALLED BY THE DISTRICT UNLESS NOTED OTHERWISE. WHERE NEW RUBBER MATTING IS INDICATED, CONSTRUCT RUBBER MAT CURB PER DETAIL. RUBBER
- RELOCATE EMPTY STORAGE CONTAINERS AND THOSE 20 FEET OR LESS IN LENGTH TO ALLOW REPAVING UNDER THEM. UNLESS NOTED OTHERWISE
- WHERE A.C. PAVEMENT IS TO BE REMOVED ADJACENT TO A RELOCATABLE BUILDING OR STORAGE CONTAINER, CUT 6" AWAY FROM THE BUILDING MUDSILL OR CONTAINER WITH A CONCRETE CUTTING
- REMOVE NON-CONFORMING EXISTING CATCH BASIN GRATES WITHIN THE WORK AREA AND REPLACE THEM WITH GRATES HAVING 3" CLEAR SPACING. USE VANDAL-RESISTANT ALHAMBRA FOUNDRY GRATES OR EQUAL TO MATCH SIZE OF EXISTING FRAMES.
- MAINTAIN A RECORD OF LOCATION OF UTILITY MARKERS ON THE AS-BUILT PLAN AND REINSTALL THEM WITH AFTER PAVING. REPLACE BENT OR UNUSABLE MARKERS. FOR ALL UTILITY LINES DISCOVERED WITHIN THE WORK AREA, INSTALL BRASS UTILITY MARKERS INDICATING DIRECTIONS OF LINES AT ALL CHANGES IN DIRECTIONS AFTER PAVING. INFORM THE SIURVEYOR TO LOCATE AND RECORD ACTUAL LOCATIONS.
- UNCLOG, CLEAN AND FLUSH THE WORK AREA DRAINAGE SYSTEM AFTER PAVING AND IMMEDIATELY BEFORE A RAIN FORECAST.
- 18. NO WORK, SUCH A REPAVING, CHAIN LINK FENCING, PLUMBING, ETC., WILL BE PERFORMED WITHIN 5 FEET OF ANY BUILDING UNLESS THE BUILDING COAT HAS BEEN TESTED TO BE FREE OF ASBESTOS OR LEAD. IF WORK WILL BE PERFORMED WITHIN 5 FEET OF A BUILDING, THE BUILDING FINISH SHALL BE TESTED BY THE DISTRICT ASBESTOS TECHNICAL UNIT (ATU). IF, BEFORE A TEST IS MADE, THE CONTRACTOR DISTURBS THE BUILDING FINISH BY ACCIDENT OR OTHEREWISE, WORK IN THAT AREA SHALL CEASE AND ATE SHALL BE NOTIFIED TO PERFORM A TEST. THEREOF, THE COST OF TESTING AND ANY NECESSARY CLEAN-UP WILL BE BORNE BY THE CONTRACTOR.

GENERAL NOTES FOR GRADING

MATTING WILL BE INSTALLED BY OTHERS.

- ALL WORK SHALL CONFIRM WITH THE GREENBOOK STANDARD SPECIFICATIONS FOR PUBLIC WORKS CONSTRUCTION (SSPWC), 2012 EDITION AND THE LATEST REVISIONS THERETO, THE WORK AREA TRAFFIC CONTROL HANDBOOK (W.A.T.C.H. MANUAL), A.D.A, TITLE 24 REQUIREMENTS, AND 2019 C.B.C. UNLESS SPECIFIED OTHERWISE IN THE CONTRACT SPECIFICATIONS.
- A COPY OF THE APPROVED GRADING PLANS MUST BE IN THE POSSESSION OF A RESPONSIBLE PERSON AND AVAILABLE AT THE JOB SITE AT ALL TIMES.
- AT LEAST TWO (2) WORKING DAYS PRIOR TO COMMENCING CONSTRUCTION, THE CONTRACTOR SHALL CONTACT THE REGIONAL NOTIFICATION CENTER (UNDERGROUND SERVICE ALERT OF SOUTHERN CALIFORNIA - U.S.A. AT 811) TO OBTAIN AN INQUIRY IDENTIFICATION NUMBER AND TO REQUEST THE UTILITY OWNERS TO MARK OR OTHERWISE INDICATE THE LOCATION OF THEIR SUBSURFACE FACILITIES. THE CONTRACTOR SHALL DETERMINE THE LOCATION AND DEPTH OF ALL UTILITIES, INCLUDING ALL SERVICE CONNECTIONS, WHICH HAVE BEEN MARKED BY THE RESPECTIVE OWNERS AND WHICH MAY AFFECT OR BE AFFECTED BY ITS OPERATIONS. THE CONTRACTOR SHALL TAKE ALL NECESSARY MEASURES TO PROTECT ALL UTILITIES AND ALL STRUCTURES FOUND AT THE SITE.
- THROUGHOUT ALL PHASES OF CONSTRUCTION, INCLUDING SUSPENSION OF WORK, UNTIL FINAL ACCEPTANCE OF THE PROJECT, THE CONTRACTOR SHALL KEEP THE WORK SITE CLEAN AND FREE FROM RUBBISH AND DEBRIS. THE CONTRACTOR SHALL ALSO ABATE DUST NUISANCE BY CLEANING, SWEEPING AND SPRINKLING WITH WATER AND USING DUST FENCES OR OTHER METHODS, AS DIRECTED BY THE CITY, THROUGHOUT THE CONSTRUCTION OPERATION.
- THE CONTRACTOR SHALL KEEP A STRICT RECORD OF ALL CHANGES THAT OCCUR DURING CONSTRUCTION PRACTICES AND SUBMIT THE RECORD TO THE SCHOOL DISTRICT CERTIFIED AS RECORD DRAWING PLANS.
- ALL DAMAGE CAUSED TO PUBLIC STREETS, INCLUDING HAUL ROUTES, ALLEYS, SIDEWALK, CURBS OR STREET FURNISHINGS, OR TO PRIVATE PROPERTY SHALL BE REPAIRED AT THE SOLE EXPENSE OF THE CONTRACTOR TO THE ENGINEER'S SATISFACTION.
- THE CONTRACTOR SHALL REMOVE AND REPLACE ANY EXISTING BROKEN OR DAMAGED SIDEWALK, CURB, GUTTER OR ASPHALT PAVING (PATCH, REPAIR OR OVERLAY) CAUSED BY THEIR WORK ON THIS PROJECT AT THE DIRECTION OF THE SCHOOL DISTRICT.
- SAWCUT EXISTING PAVEMENT AS DIRECTED BY THE JOB INSPECTOR.
- WHERE JOINING THE EXISTING PAVEMENT, SAWCUT TO SOUND PAVEMENT AND OVERLAY AS REQUIRED TO PROVIDE PROPER GRADE AND 2% MAX. CROSS-SLOPE. ANY UNSOUND PAVEMENT SHALL BE REPLACED AS REQUIRED BY THE ENGINEER.
- AT LEAST TWO (2) WORKING DAYS BEFORE COMMENCING EXCAVATION, THE CONTRACTOR SHALL POTHOLE AND EXPOSE THE EXISTING UTILITIES AT ALL CROSSINGS AND AT THE POINT OF TIE-IN; THEN CONTACT THE ENGINEER TO VERIFY THE ELEVATION OF THE EXISTING FACILITIES.
- THE CONTRACTOR SHALL BE RESPONSIBLE FOR PROVIDING STORM DAMAGE PREVENTION MEASURES OR EROSION CONTROL DEVICES AND/OR TO PERFORM CERTAIN GRADING TO PREVENT SOIL OR EXCESS RUNOFF FROM FLOWING INTO PUBLIC STREETS OR ADJACENT PROPERTIES. IN THE EVENT OF SUCH AN OCCURANCE, CLEANUP SHALL COMMENCE IMMEDIATELY. SHOULD CITY FORCES OR THE CITY CONTRACTOR PERFORM ANY CLEANUP RESULTING FROM THIS DEVELOPMENT, THE CONTRACTOR SHALL PAY THE COST INCURRED WITHIN TEN (10) WORKING DAYS UPON RECEIPT OF BILLING.
- EITHER WATER OR DUST PALLIATIVE, OR BOTH, MUST BE APPLIED FOR THE ALLEVIATION OR PREVENTION OF EXCESSIVE DUST RESULTING FROM THE LOADING OR TRANSPORTATION OF EARTH FROM OR TO THE PROJECT SITE OR PRIVATE AND PUBLIC ROADWAYS.
- FINE GRADING TO BE NO LESS THAN THE FOLLOWING UNLESS STATED OTHERWISE ON THE PLANS:

	CROSS SLOPE	LONGITUDINAL SLOPE
PERVIOUS SURFACES	2.00%	1.00%
ASPHALT SURFACES	1.00%	1.00%
CONCRETE SURFACES	0.50%	0.50%

- 4. EVERY EFFORT SHOULD BE MADE TO ELIMINATE THE DISCHARGE ON NON-STORMWATER FROM THE PROJECT SITE AT ALL TIMES.
- ALL TRUCKS HAULING DIRT, SAND, OIL, OR OTHER LOOSE MATERIALS ARE TO BE COVERED OR SHOULD MAINTAIN AT LEAST TWO FEET OF FREEBOARD IN ACCORDANCE WITH THE REQUIREMENTS OF CVC
- 6. CONTRACTOR TO PROVIDE DUST CONTROL DURING ALL GRADING AND TRENCHING OPERATIONS. **UNAUTHORIZED CHANGES & USES**

CAUTION: THE ENGINEER PREPARING THESE PLANS WILL NOT BE RESPONSIBLE FOR,

OR LIABLE FOR, UNAUTHORIZED CHANGES TO OR USES OF THESE PLANS. ALL CHANGES TO THE PLANS MUST BE IN WRITING AND MUST BE APPROVED BY THE PREPARER OF

NOTICE TO CONTRACTOR:

IT IS A REQUIREMENT OF THESE PLANS THAT ALL WORK DEDPICTED HEREON SHALL BE STAKED BY A LICENSED LAND SURVEYOR AS DEFINED BY THE STATE OF CALIFORNIA. FAILURE TO COMPLY WITH THIS REQUIREMENT WILL RESULT IN THE CONTRACTOR BEING HELD FULLY LIABLE FOR ANY ERRORS IN THE DESIGN AND CONSTRUCTION OF THE IMPROVEMENTS.

BY WORKING FROM THESE PLANS THE CONTRACTOR AND HIS SUBCONTRACTORS ACKNOWLEDGE THAT THEY HAVE REVIEWED THESE PLANS THOROUGHLY AND UNDERSTAND THE DESIGN INTENT IMPLIED BY THE PLANS. THE CONTRACTOR FURTHER ACKNOWLEDGES THAT ONLY QUALIFIED FIELD PERSONNEL OF THE CONTRACTOR AND SUBCONTRACTOR ARE TO BE UTILIZED IN IMPLEMENTING THE ENGINEER'S DESIGN INTENT. FURTHER THE CONTRACTOR ACKNOWLEDGES THAT HIS FIELD PERSONNEL FULLY UNDERSTAND THE DESIGN INTENT OF THESE PLANS.

PORTLAND CEMENT CONCRETE (PCC)

- 1. ALL MATERIAL AND INSTALLATION OF PCC PAVING AND CURBS SHALL CONFORM TO THE STANDARD SPECIFICATIONS FOR PUBLIC WORKS CONSTRUCTION, "LATEST EDITION".
- 2. CONTRACTOR SHALL OBTAIN ALL PCC FROM THE SAME SOURCE THROUGHOUT THE COURSE OF CONSTRUCTION.
- 3. CONTRACTOR SHALL SUBMIT PCC DESIGN MIX FOR REVIEW AND APPROVAL BY THE ENGINEER.
- 4. PCC PAVING IN SIDEWALKS SHALL HAVE A MINIMUM COMPRESSIVE STRENGTH OF 3,500 PSI AT 28 DAYS. DESIGN MIX SHALL PROVIDE A 4" TO 6" SLUMP, AND A MINIMUM OF 5.5 SACKS/CY OF CEMENT AND 2-4% AIR ENTRAINMENT.
- 5. ALL PCC MATERIALS SHALL COMPLY WITH ASTM C150 NORMAL TYPE-I PORTLAND TYPE, GRAY COLOR U.N.O. FINE AND COURSE AGGREGATES SHALL COMPLY WITH ASTM C33 AND SHALL BE NON REACTIVE. ALL WATER SHALL BE CLEAN AND NON DETRIMENTAL TO CONCRETE.
- CONTRACTOR SHALL APPLY A CURING COMPOUND CONFORMING TO ASTM C309 TYPE I-D, CLASS B ON ALL PCC SURFACES. APPLICATION TO CONFORM TO MANUFACTURES INSTRUCTIONS.
- 7. CONTRACTOR SHALL PROVIDE CONTROL JOINTS AS SHOWN ON THE ARCHITECT'S PROJECT
- 8. CONTRACTOR SHALL PROVIDE A SMOOTH FORM FINISH FOR ALL CURBS. PROVIDE BROOM FINISH FOR ALL ONSITE SIDEWALKS
- 9. CONTRACTOR SHALL PROTECT ALL PCC SURFACES FROM PEDESTRIAN TRAFFIC FOR 7 DAYS AND VEHICLE TRAFFIC FOR 14 DAYS. CONTRACTOR SHALL PROTECT PCC FROM PREMATURE DRYING, EXCESSIVE HOT OR COLD TEMPERATURES.
- 10. CONTRACTOR SHALL MAINTAIN A MAXIMUM VARIATION OF SURFACE FLATNESS OF 1/4" IN 10 FEET AND A MAXIMUM VARIATION FROM TRUE POSITION OF 1/4".
- 11. PAYMENT FOR PROVIDING ALL LABOR, MATERIALS, AND EQUIPMENT TO CONSTRUCT THE PCC SIDEWALKS, CURB & PAVING AND ASSOCIATED APPURTENANCES DEPICTED HEREIN SHALL BE BASED UPON THE SPECIFIC UNIT QUANTITY FOR EACH ITEM AND NO ADDITIONAL COMPENSATION WILL BE ALLOWED THEREFORE.

SPECIAL NOTES

- 1. THE FOLLOWING NOTES ARE PROVIDED TO GIVE DIRECTIONS TO THE CONTRACTOR BY THE ENGINEER OF WORK.
- 2. PRIOR TO THE START OF CONSTRUCTION, THE CONTRACTOR SHALL EXAMINE ALL PLANS AND CONTRACT DOCUMENTS AND SHALL INSPECT THE EXISTING CONDITIONS IN THE FIELD AND SHALL REPORT IN WRITING ANY DISCREPANCY THUS NOTED TO THE ENGINEER OF WORK.
- THE CONTRACTOR SHALL BE RESPONSIBLE FOR OBTAINING THE APPROPRIATE PERMITS FOR ALL WORK TO BE DONE, PRIOR TO INITIATING SUCH WORK.
- NEITHER THE OWNER NOR THE ENGINEER OF WORK WILL ENFORCE SAFETY MEASURES OR DEVICES INCLUDING SHORING AND SHALL BE SOLELY RESPONSIBLE FOR CONFORMING TO ALL LOCAL, STATE AND FEDERAL SAFETY AND HEALTH STANDARDS, LAWS AND REGULATIONS.
- 5. ALL LABOR AND MATERIALS FOR THIS PROJECT SHALL BE FURNISHED AND INSTALLED BY THE CONTRACTOR, UNLESS OTHERWISE SPECIFIED.
- THE CONTRACTOR SHALL BE RESPONSIBLE FOR IMPORTING AND/OR EXPORTING ALL MATERIAL AS REQUIRED TO PROPERLY GRADE THIS PROJECT TO THE FINISHED GRADES SHOWN HEREON IN ACCORDANCE WITH THE APPROVED PLANS, AND THE SOILS ENGINEERS RECOMMENDATIONS.
- THE CONTRACTOR SHALL TAKE PROTECTIVE MEASURES TO PREVENT THE ACCUMULATION OF MUD ON PUBLIC STREETS, AND SHALL CONTROL DUST.
- 8. THE CONTRACTOR SHALL TAKE ALL NECESSARY PRECAUTIONS REQUIRED TO PROTECT ADJACENT PROPERTIES AND/OR FACILITIES DURING GRADING OPERATIONS. ANYTHING DISTURBED, DAMAGED, OR DESTROYED SHALL BE ADJUSTED, REPAIRED OR REPLACED TO THE CONDITION EXISTING PRIOR
- 9. ELEVATIONS AND CONTOURS SHOWN HEREON ARE TO FINISH GRADE UNLESS OTHERWISE NOTED. DURING GRADING, THE CONTRACTOR SHALL MAKE ALLOWANCES IN PAVED AREAS, AND LANDSCAPE AREAS TO ACCOMMODATE STRUCTURAL SECTIONS.
- 10. ALL GRADED SURFACES SHALL PROVIDE POSITIVE DRAINAGE AND PREVENT PONDING OF WATER. THE CONTRACTOR SHALL CONTROL ALL SURFACE WATER TO AVOID DAMAGE TO ADJOINING PROPERTIES OR TO FINISH WORK ON THE SITE, AND SHALL TAKE REMEDIAL MEASURES TO PREVENT EROSION OF FRESHLY GRADED AREAS UNTIL PERMANENT DRAINAGE CONTROL MEASURES HAVE BEEN INSTALLED.
- 11. GRADING TOLERANCES: VERTICAL + 0.1', HORIZONTAL + 0.5'. THESE LIMITS DO NOT RELIEVE THE CONTRACTORS RESPONSIBILITY FOR PROVIDING A FINISHED SURFACE THAT WILL NOT POND

ASPHALT CONCRETE PAVING (AC)

TO GRADING AT THE CONTRACTOR'S EXPENSE

- ALL MATERIAL AND INSTALLATION OF AC PAVING AND AGGREGATE BASE SHALL CONFORM TO THE STANDARD SPECIFICATIONS FOR PUBLIC WORKS CONSTRUCTION, "LATEST
- 2. CONTRACTOR SHALL SUBMIT PROPOSED DESIGN MIX FOR REVIEW AND APPROVAL PRIOR TO START OF CONSTRUCTION.
- CONTRACTOR SHALL NOT PLACE AC PAVING WHEN BASE SURFACE TEMPERATURE IS LESS
- 4. CONTRACTOR SHALL APPLY A SEAL COAT TO THE AC PAVING AREAS IN ACCORDANCE MANUFACTURER'S INSTRUCTIONS. DO NOT APPLY SEAL COAT UNTIL 30 DAYS AFTER
- CONTRACTOR SHALL PROTECT AC PAVING IMMEDIATELY AFTER PLACEMENT FROM MECHANICAL INJURY FOR TWO DAYS.
- 6. CONTRACTOR SHALL PERFORM A FLOOD TEST OF THE FINISHED AC PAVING. TEST SHALL BE CONDUCTED IN THE PRESENCE OF THE DISTRICT'S REPRESENTATIVE. WHERE WATER PONDS MORE THAN 1/8", CONTRACTOR SHALL FILL OR OTHERWISE CORRECT AC PAVING TO PROVIDE PROPER DRAINAGE.
- 7. CONTRACTOR SHALL PLACE AC PAVING IN one LIFT.

PLACING AC PAVING.

- CONTRACTOR SHALL APPLY A "TACK COAT" BETWEEN PAVEMENT LAYER, AND CONCRETE SURFACES AT A RATE OF 0.10 GAL/ YD. TACK COAT SHALL COMPLY WITH THE APPLICABLE SECTIONS OF THE STANDARD SPECIFICATIONS FOR PUBLIC WORKS CONSTRUCTION.
- 9. AC PAVING SHALL BE B2-AR-4000 FOR BASE COURSE AND C2-AR-4000 FOR FINISH COURSE.

GENERAL EROSION CONTROL NOTES

- A STAND-BY CREW FOR EMERGENCY WORK SHALL BE AVAILABLE AT ALL TIMES DURING THE RAINY SEASON (OCTOBER 15 TO APRIL 15). NECESSARY MATERIAL SHALL BE AVAILABLE ONSITE AND STOCKPILED AT CONVENIENT LOCATIONS TO INSURE THE RAPID CONSTRUCTION OF EMERGENCY DEVICES. CONTACT BRENT GRIFFIN AT (562) 577-2139 IN CASE OF EMERGENCY.
- EROSION CONTROL DEVICES SHOWN ON THIS PLAN MAY BE REMOVED WHEN APPROVED BY THE ENGINEER IF THE GRADING OPERATION HAS PROGRESSED TO THE POINT WHERE THEY ARE NO LONGER REQUIRED.
- 3. ALL DEVICES SHOWN ON THE PLAN SHALL BE IN PLACE AT THE END OF EACH WORKING DAY OR ON WEEKENDS WHEN THE 5 DAY RAIN PROBABILITY FORECAST EXCEEDS 40%.
- 4. GRADED AREAS ADJACENT TO FILL SLOPES LOCATED AT THE SITE PERIMETER MUST DRAIN AWAY FROM TOP OF SLOPE AT THE CONCLUSION OF EACH WORKING DAY.
- 5. ALL LOOSE SOIL AND DEBRIS WHICH MAY CREATE A POTENTIAL HAZARD TO OFFSITE PROPERTY SHALL BE REMOVED FROM THE SITE.
- 6. ALL SILT AND DEBRIS SHALL BE REMOVED FROM ALL DEVICES WITHIN 24 HOURS AFTER EACH

7. THE PLACEMENT OF ADDITIONAL DEVICES TO REDUCE EROSION DAMAGE WITHIN THE SITE IS

- 8. THE ENTRANCE SHALL BE MAINTAINED IN A CONDITION THAT WILL PREVENT TRACKING OR FLOWING OF SEDIMENT ONTO THE PUBLIC RIGHTS-OF-WAY. THIS MAY REQUIRE PERIODIC REPAVING AS CONDITIONS DEMAND, AND REPAIR AND/OR CLEANOUT OF ANY MEASURES USED
- 9. WHEN NECESSARY WHEELS SHALL BE CLEANED TO REMOVE SEDIMENT PRIOR TO ENTRANCE ONTO PUBLIC RIGHTS-OF-WAY. WHEN WASHING IS REQUIRED, IT SHALL BE DONE ON AN AREA STABILIZED WITH CRUSHED STONE THAT DRAINS INTO AN APPROVED SEDIMENT TRAP OR SEDIMENT BASIN. ALL SEDIMENT SHALL BE PREVENTED FROM ENTERING ANY STORM DRAIN. DITCH OR WATER COURSE THROUGH USE OF SANDBAGS, GRAVEL BOARDS OR OTHER

TO TRAP SEDIMENT. ALL SEDIMENT SPILLED, DROPPED, WASHED OR TRACKED ONTO PUBLIC

NOTICE TO CONTRACTOR

LEFT TO THE DISCRETION OF THE FIELD ENGINEER.


RIGHTS-OF-WAY SHALL BE REMOVED IMMEDIATELY.

CONSTRUCTION CONTRACTOR AGREES THAT IN ACCORDANCE WITH GENERALLY ACCEPTED CONSTRUCTION PRACTICES, CONSTRUCTION CONTRACTOR WILL BE REQUIRED TO ASSUME SOLE AND COMPLETE RESPONSIBILITY FOR JOB SITE CONDITIONS DURING THE COURSE OF CONSTRUCTION OF THE PROJECT, INCLUDING SAFETY OF ALL PERSONS AND PROPERTY: THAT THIS REQUIREMENT SHALL BE MADE TO APPLY CONTINOUSLY AND NOT BE LIMITED TO NORMAL WORKING HOURS, AND CONSTRUCTION CONTRACTOR FURTHER AGREES TO DEFEND, INDEMNIFY AND HOLD DESIGN PROFESSIONAL HARMLESS FROM ANY AND ALL LIABILITY, REAL OR ALLEGED, IN CONNECTION WITH THE PERFORMANCE OF WORK ON THIS PROJECT, EXCEPTING LIABILITY ARISING FROM THE SOLE NEGLIGENCE OF DESIGN PROFESSIONAL.

PRECISE GRADING PLAN


FOR

WILLIAM ORR ELEMENTARY SCHOOL 12130 S. JERSEY AVENUE, NORWALK, CA 90650

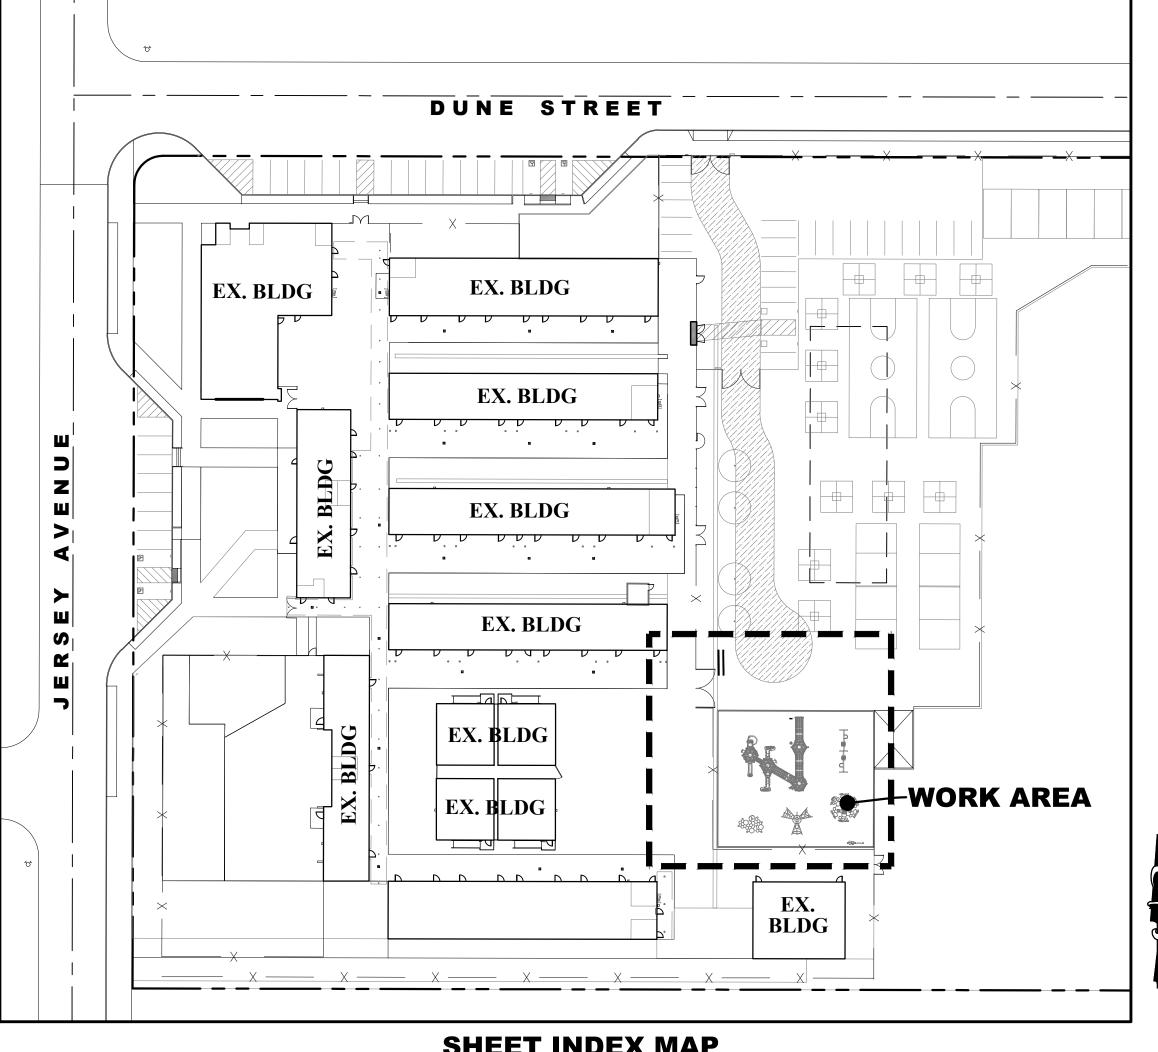

SHEET INDEX MAP

LEGENDS & ABBREVATIONS

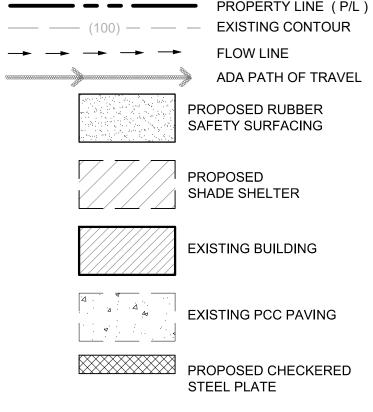

- AGGREGATE BASE ASPHALTIC CONCRETE - BUILDING CENTERLINE CONCRETE EDGE OF PAVEMENT - GUARD POST - INVERT - NUMBER - PAGES - PROPERTY LINE REGISTERED CIVIL ENGINEER SEWER CLEANOUT - TOP OF CURB TYPICAL TOP OF WALL PORTLAND CEMENT CONCRETE EDGE OF PAVEMENT - FINISH SURFACE - SQUARE LINEAR FOOT TOP OF GRATE - FLOW LINE SQUARE FOO[®] - STANDARD - MOW CURB GRADE BREAK OVERHANG - METAL SFWFR CYCLONE FENCE - CORNER

- TOP OF BLOCK

THE CONTRACTOR SHALL BE RESPONSIBLE FOR PREPARING THE

REQUIRED STORM WATER POLLUTION PREVENT PLAN FOR THE

PROJECT IN ACCORDANCE WITH REGIONAL WATER QUALITY

CONSTRUCTION QUANTITIES SHOWN ON THESE PLANS ARE

CONTRACTOR SHALL TAKE OFF THEIR OWN QUANTITIES FOR

BIDDING PURPOSES. PAYMENT FOR ALL ITEMS WILL BE BASED

UPON CONTRACTOR'S NUMBERS AND NOT THE QUANTITIES ON

PROVIDED FOR THE CONTRACTOR'S REFERENCE ONLY.

NOTICE TO CONTRACTOR:

NOTE:

CONTROL STANDARDS.

THESE PLANS.

KENNEY ST. **DUNE ST PROJECT** CREWE S **SPRY ST** EVEREST ST. **GETTYBURG DR VICINITY MAP**

BENCHMARK:

LOS ANGELES COUNTY PUBLISHED BENCHMARK EY8725 WITH ELEVATION OF 115.778' USED TO ESTABLISHED VERTICAL CONTROL

2 CONSTRUCT 3" TYPE II AC PAVING OVER 6" CMB 90% COMPACTED SUBGRADE. 2,054 S.F 3 CONSTRUCT CONCRETE BLOCK HEIGHT VARIES FROM 0" TO 4.67". FOR DETAIL SEE SECTION G-G. 26 L.F.	CONSTRUCTION NOTES	& QUANTITII
90% COMPACTED SUBGRADE. 2,054 S.I CONSTRUCT CONCRETE BLOCK HEIGHT VARIES FROM 0" TO 4.67". FOR DETAIL SEE SECTION G-G. 26 L.F.	AGGREGATE BASE PER ARCHITECTURAL DETAIL 1 ON	5,082 S.F.
		2,054 S.F.
4) INSTALL ½" CHECKERED GALVANIZED STEEL PLATE.	3 CONSTRUCT CONCRETE BLOCK HEIGHT VARIES FROM 0" TO 4.67". FOR DETAIL SEE SECTION G-G.	26 L.F.
MAXIMUM WIDTH = 2'-2". 42 S.F.	4 INSTALL ¼" CHECKERED GALVANIZED STEEL PLATE. MAXIMUM WIDTH = 2'-2".	42 S.F.

DEMOLITION NOTES


A PROTECT IN PLACE.	1 L.S.
B REMOVE AND DISPOSE OF EX. POURED-IN-PLACE RUBBER SAFETY SURFACE.	5,075 S.F.
C REMOVE AND DISPOSE OF EX. GATE.	1 EA
D REMOVE AND DISPOSE OF EX. PLAYGROUND EQUIPMENT AND FOOTINGS IN ITS ENTIRETY.	1 L.S.
E REMOVE AND DISPOSE OF EX. BENCH.	2 EA
F REMOVE AND DISPOSE OF EX. AC PAVING.	1,977 S.F.

SHEET INDEX

SHEET CO.0 - TITLE SHEET SHEET C1.0 - DEMOLITION PLAN SHEET C2.0 - PRECISE GRADING PLAN SHEET C3.0 - EROSION CONTROL PLAN

PREPARED UNDER THE DIRECT SUPERVISION OF


Ent M. Sge

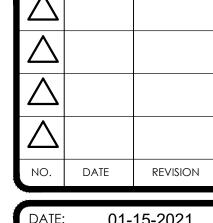

01-15-2021 JOB NO.: 1424-080-01X DRAWN BY: CHECKED BY: KMS






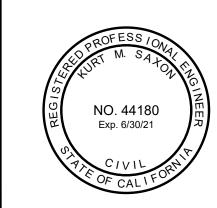



SHEET NO.

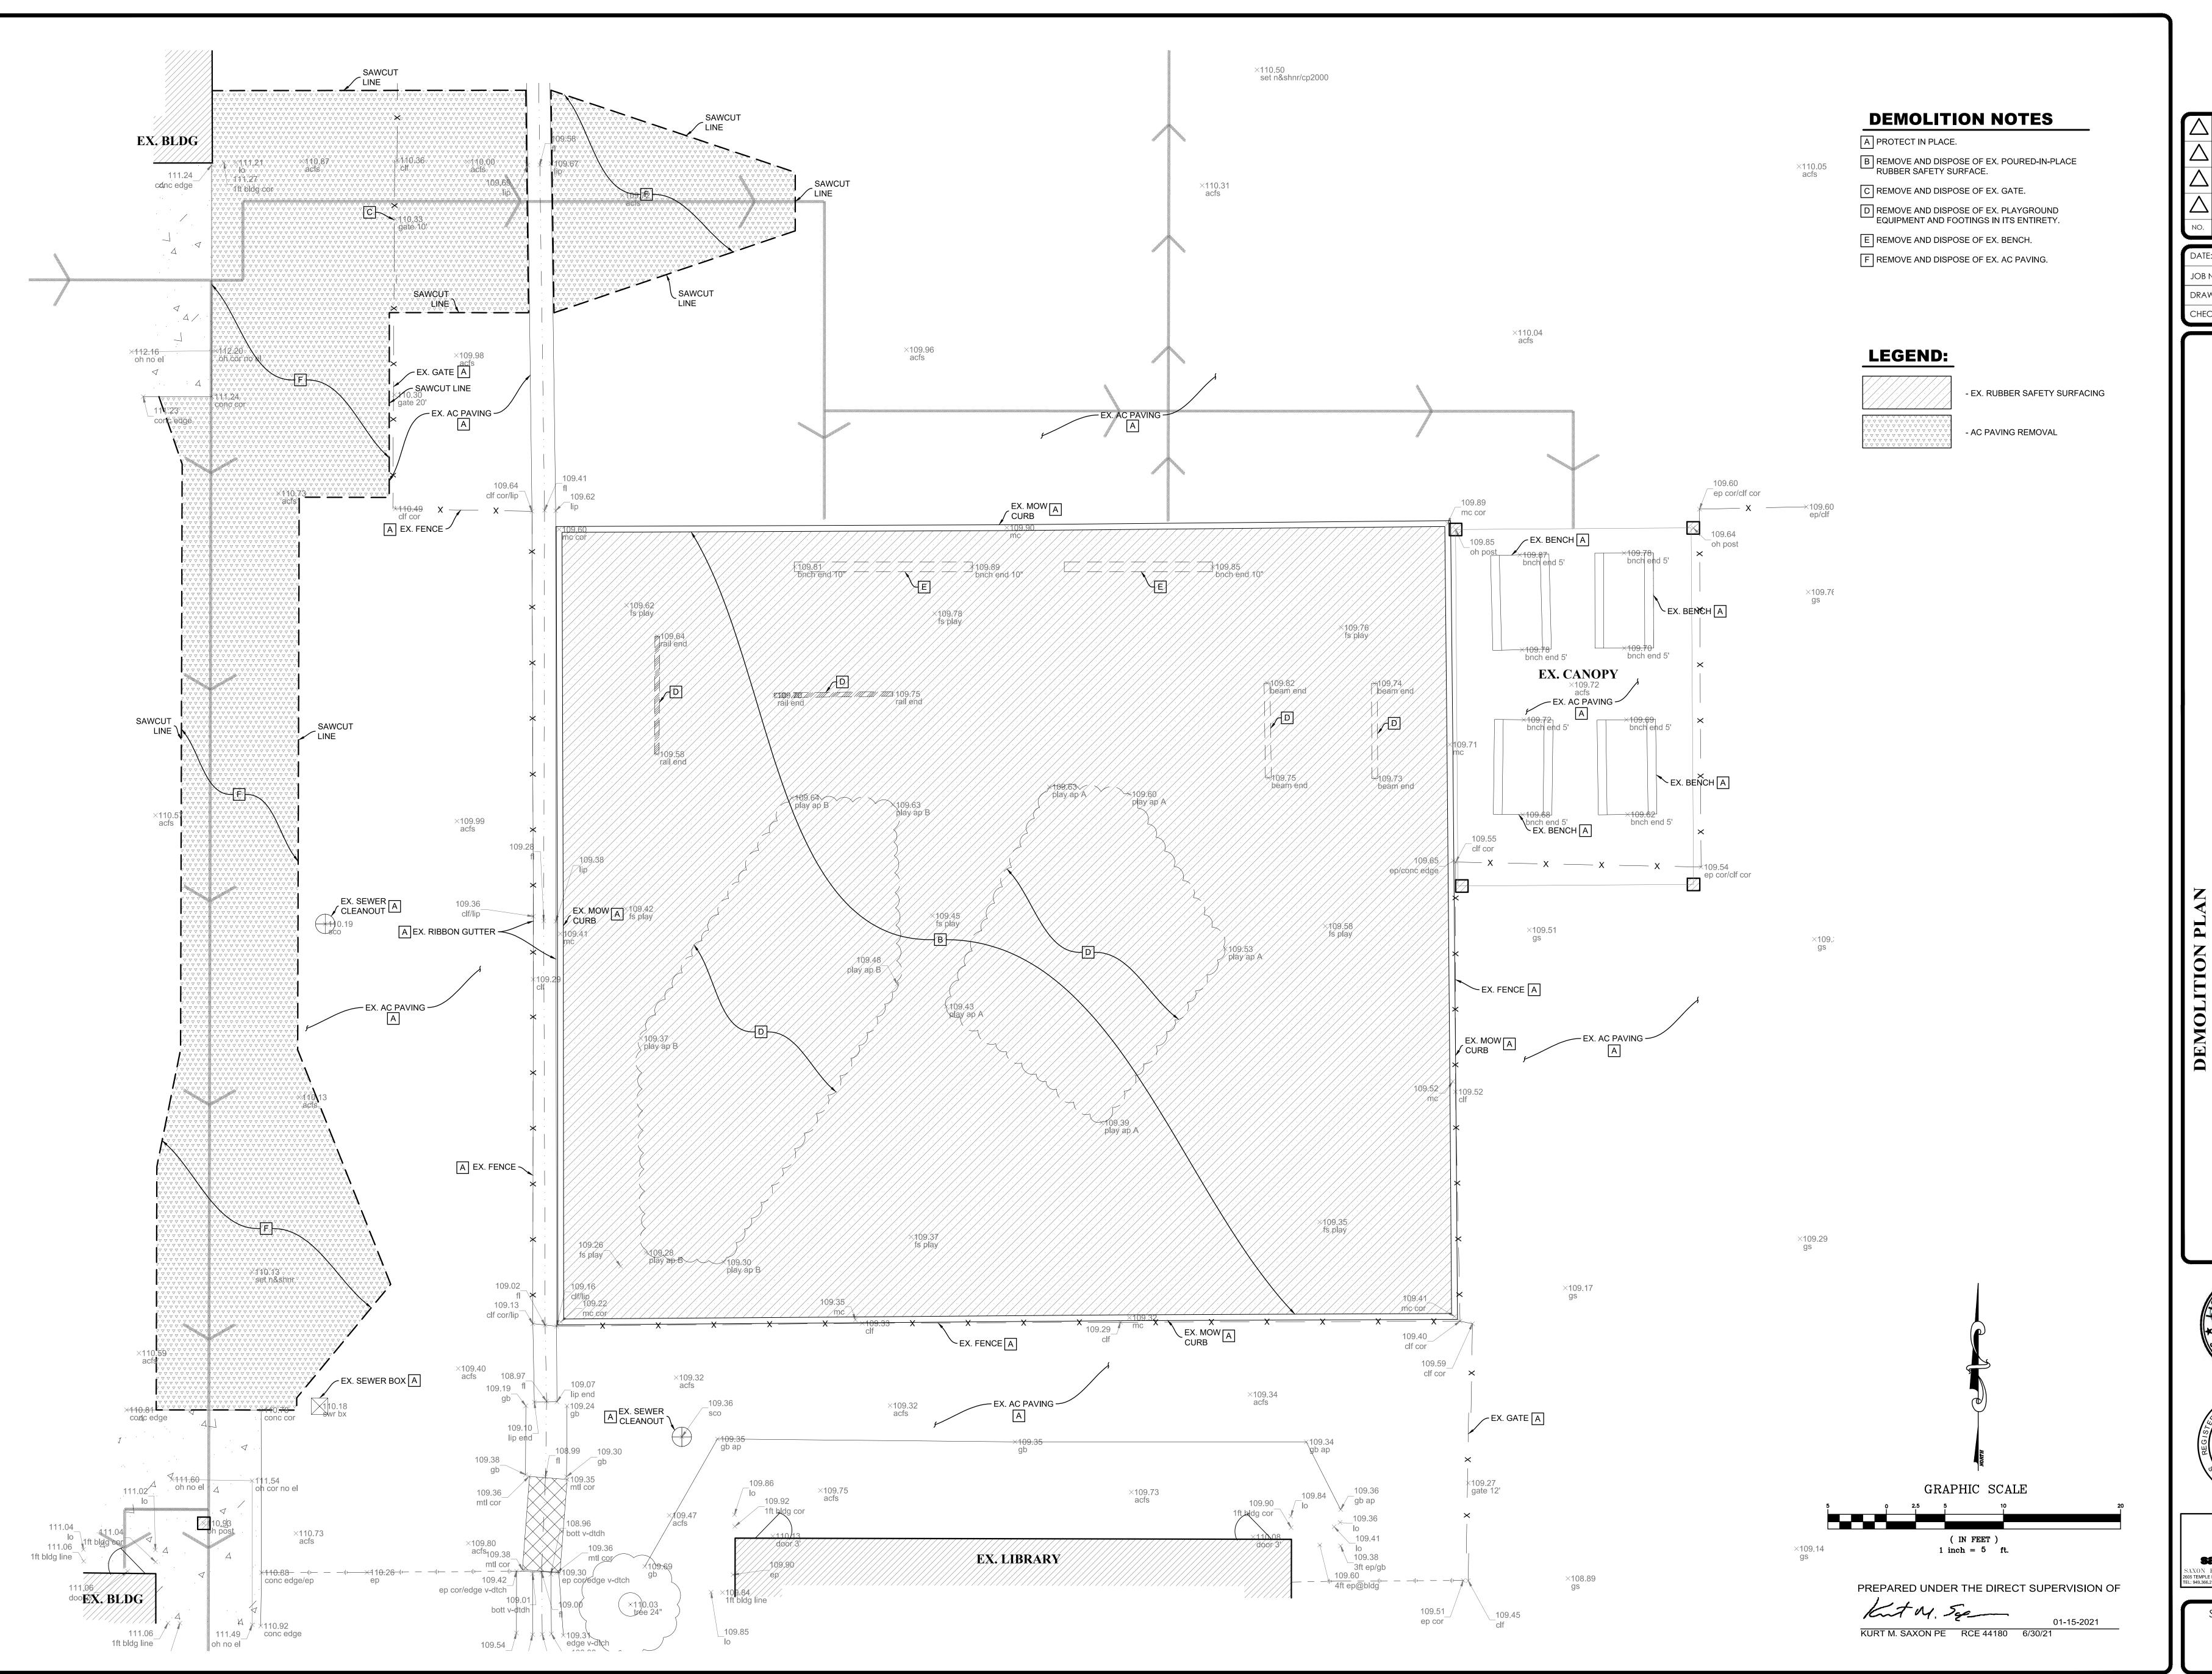

2021-01-30 - 12:42PM

DATE

DATE: **01-15-2021** JOB NO.: 1424-080-01X DRAWN BY: SC


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ARCHITECTS


3 400 • Burbank, CA 91502







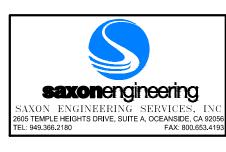

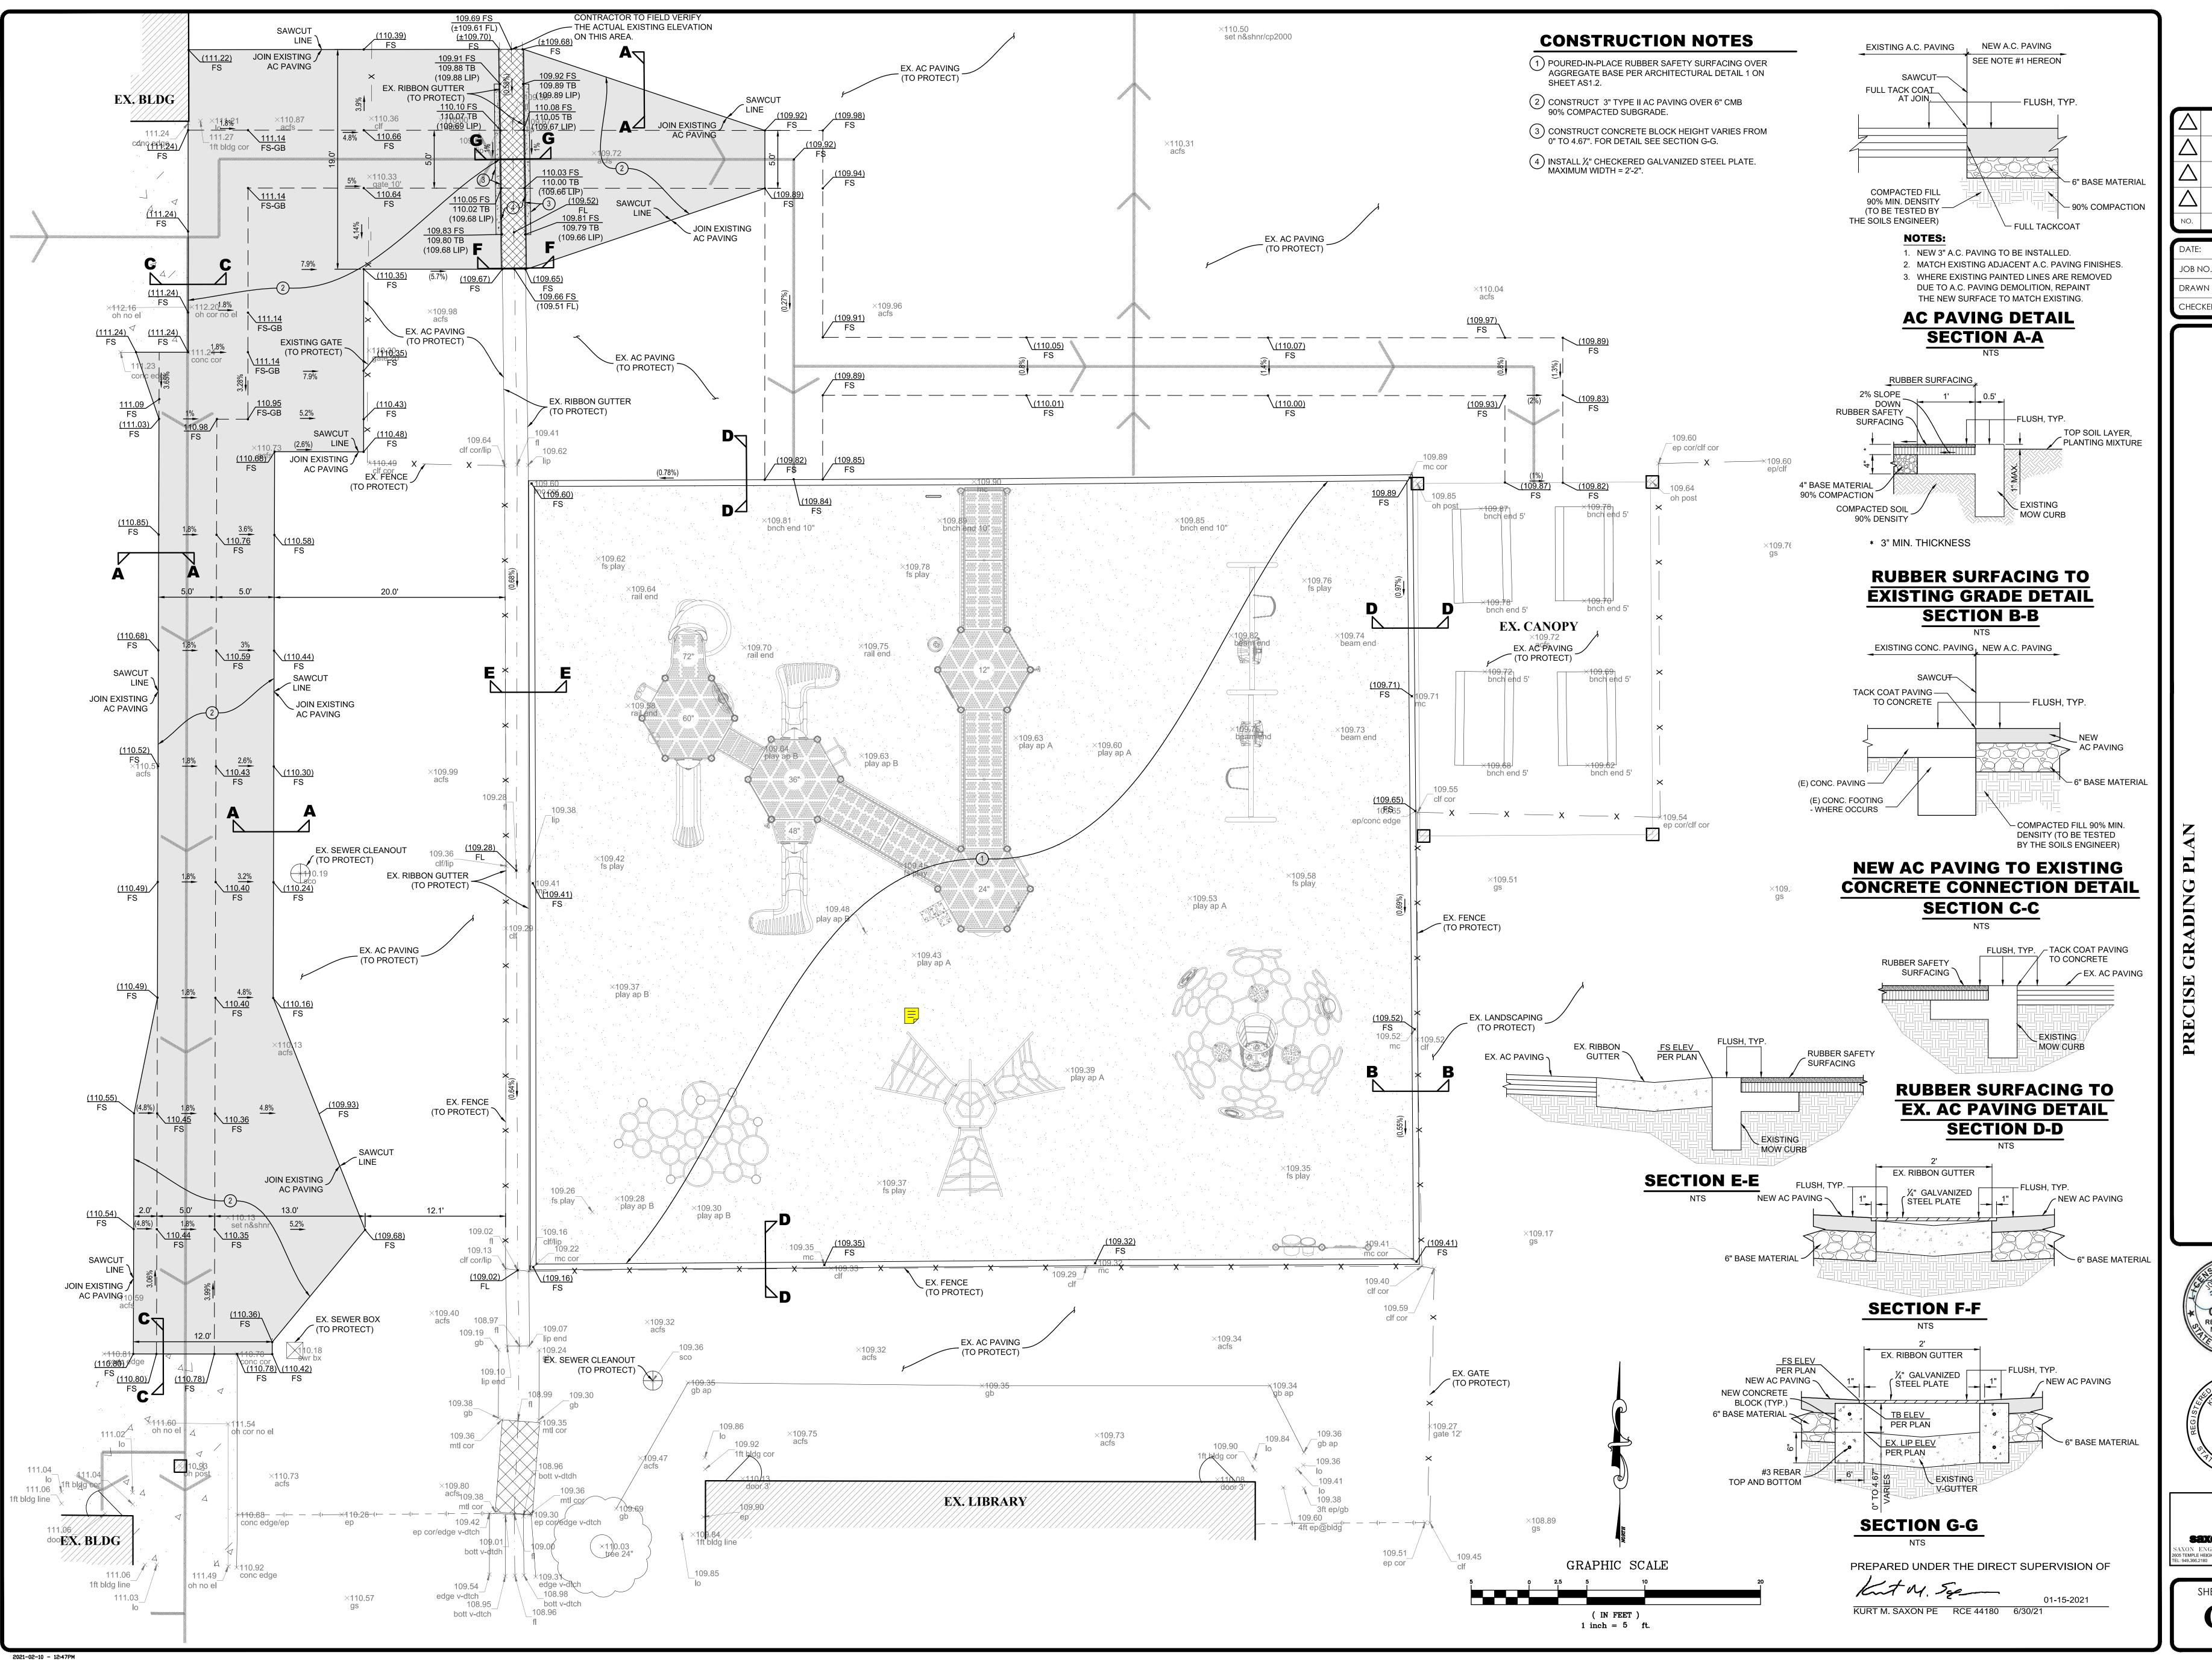

DATE

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RCHITECT

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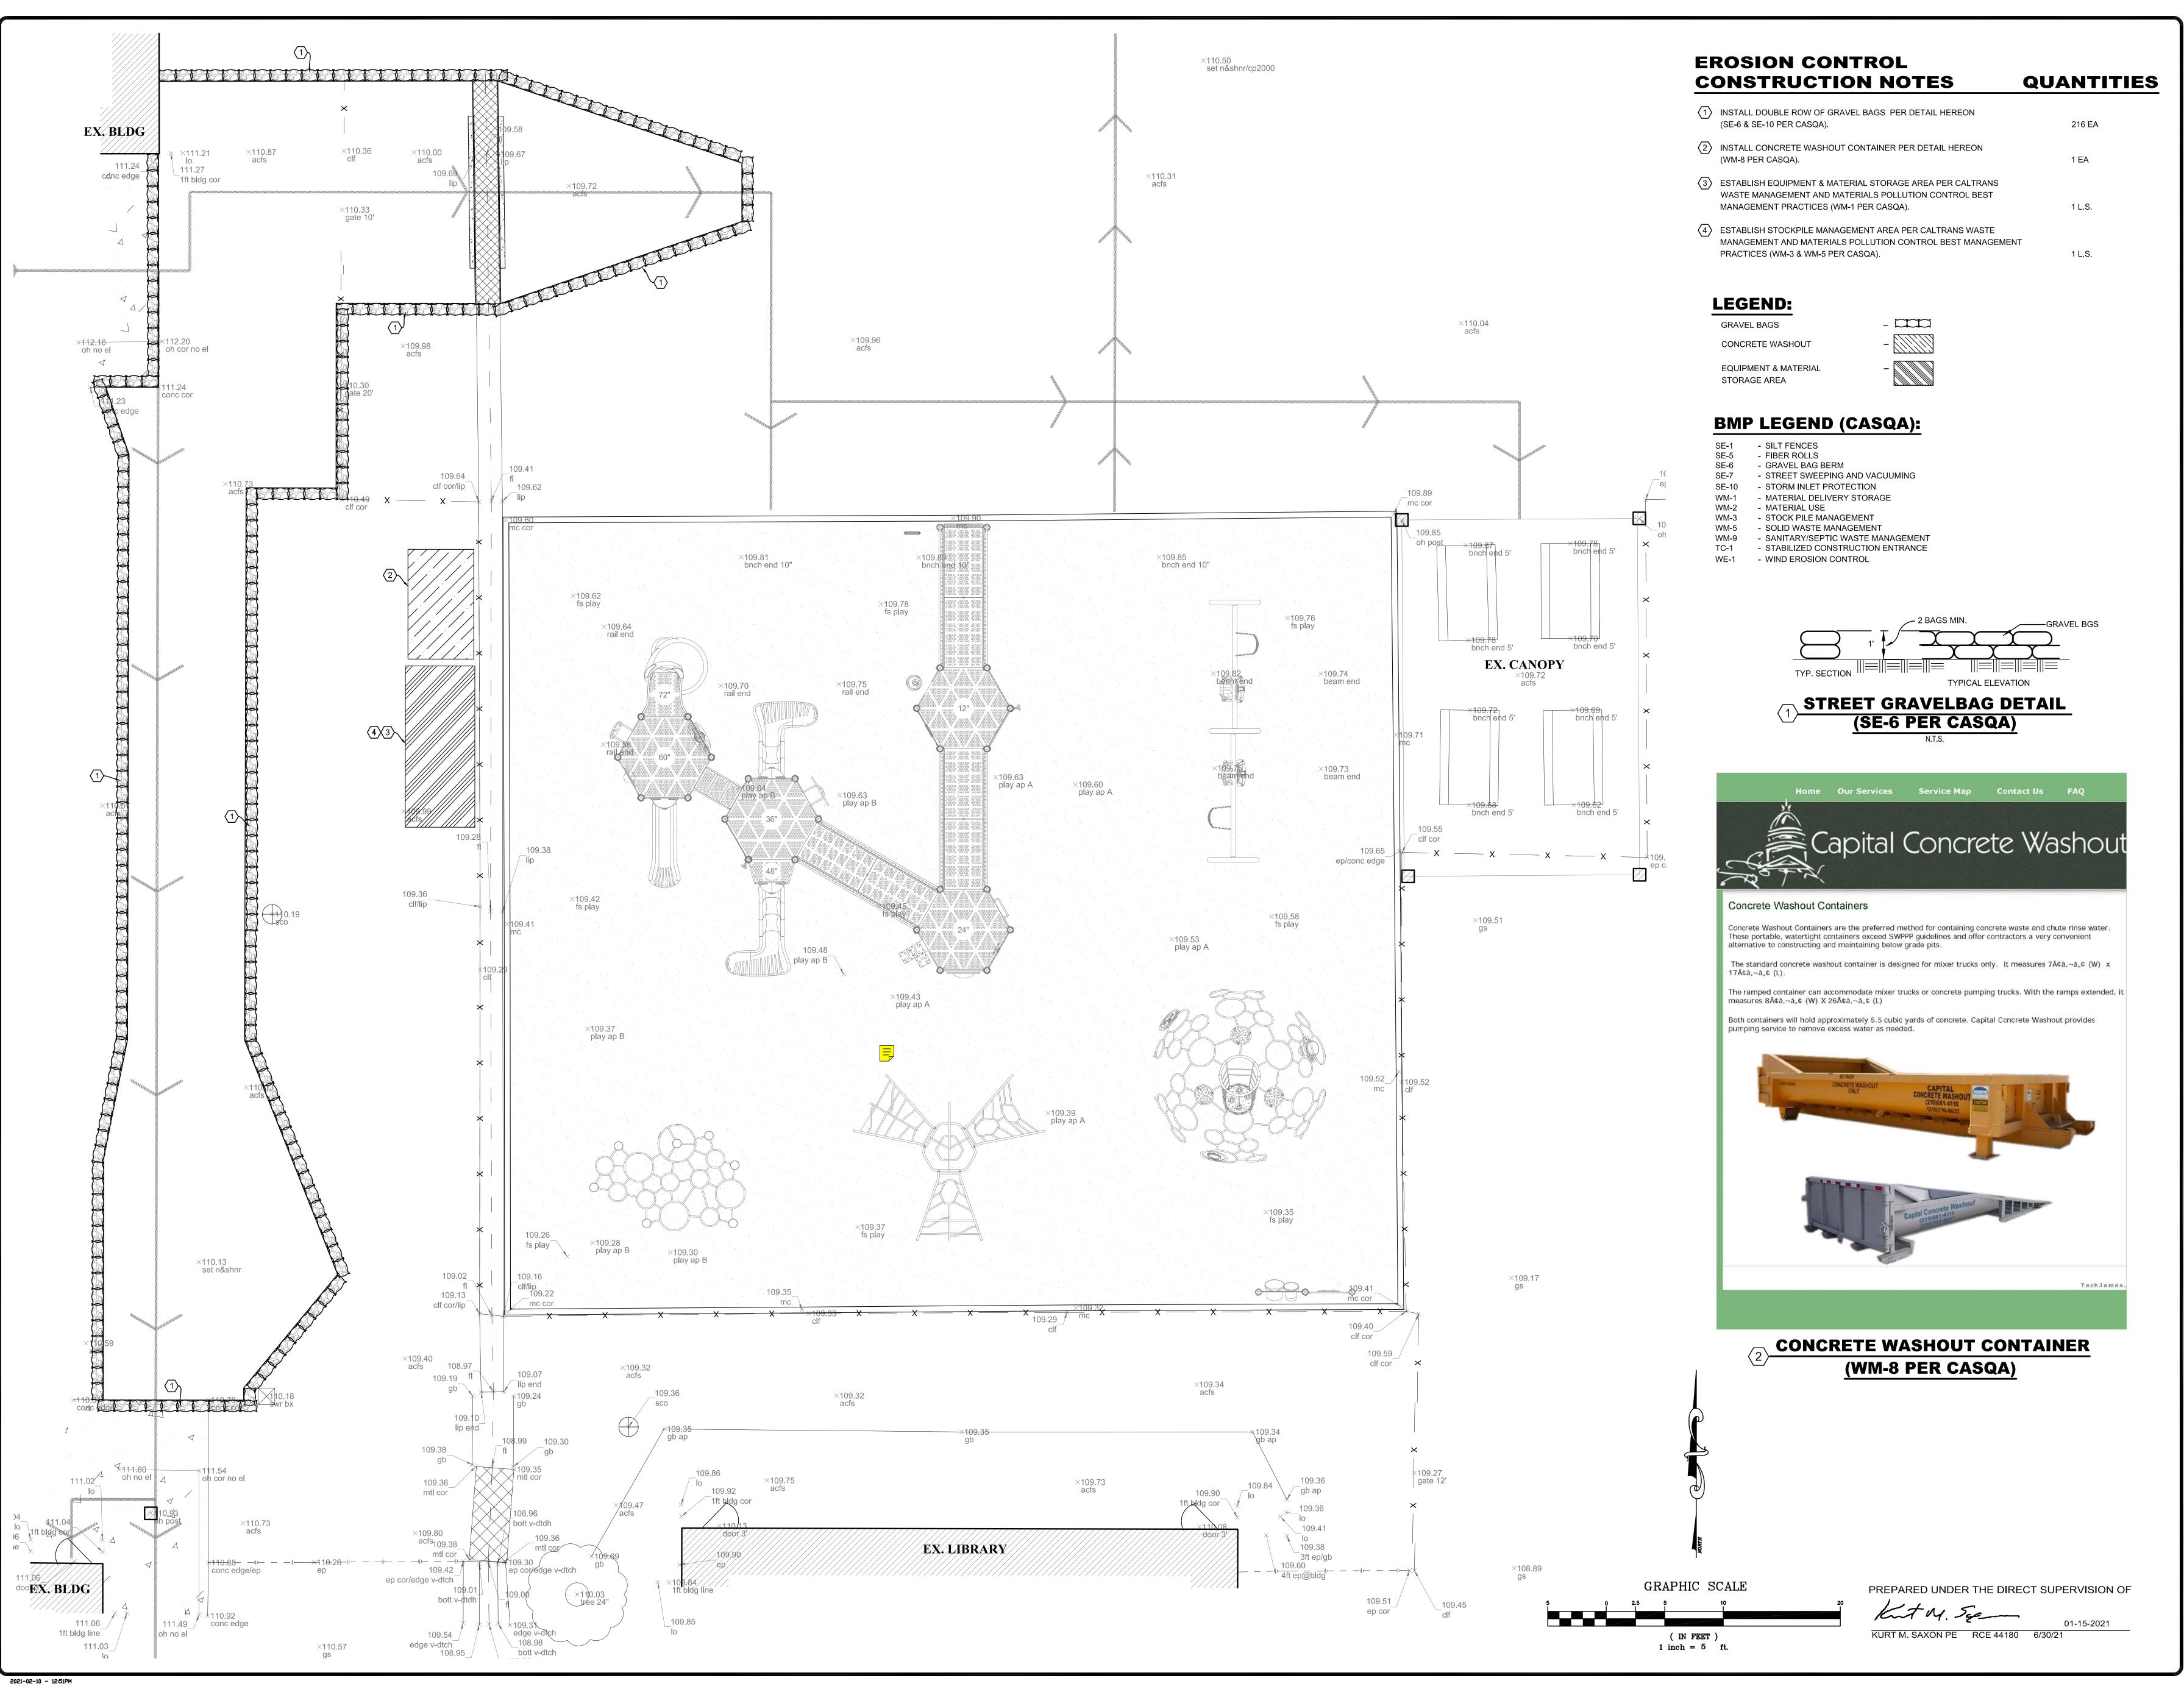
ROUND EQUIPME

C-33216
RENEWAL DATE
NOV. 30, 2021





SHEET NO. C2.0




REVISION DATE

DATE: **01-15-2021** JOB NO.: 1424-080-01X DRAWN BY: SC CHECKED BY: KMS


ARCHITECTS
400 • Burbank, CA 9150



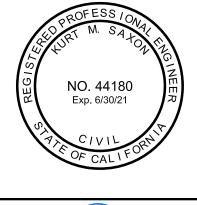



SHEET NO. **C3.0**

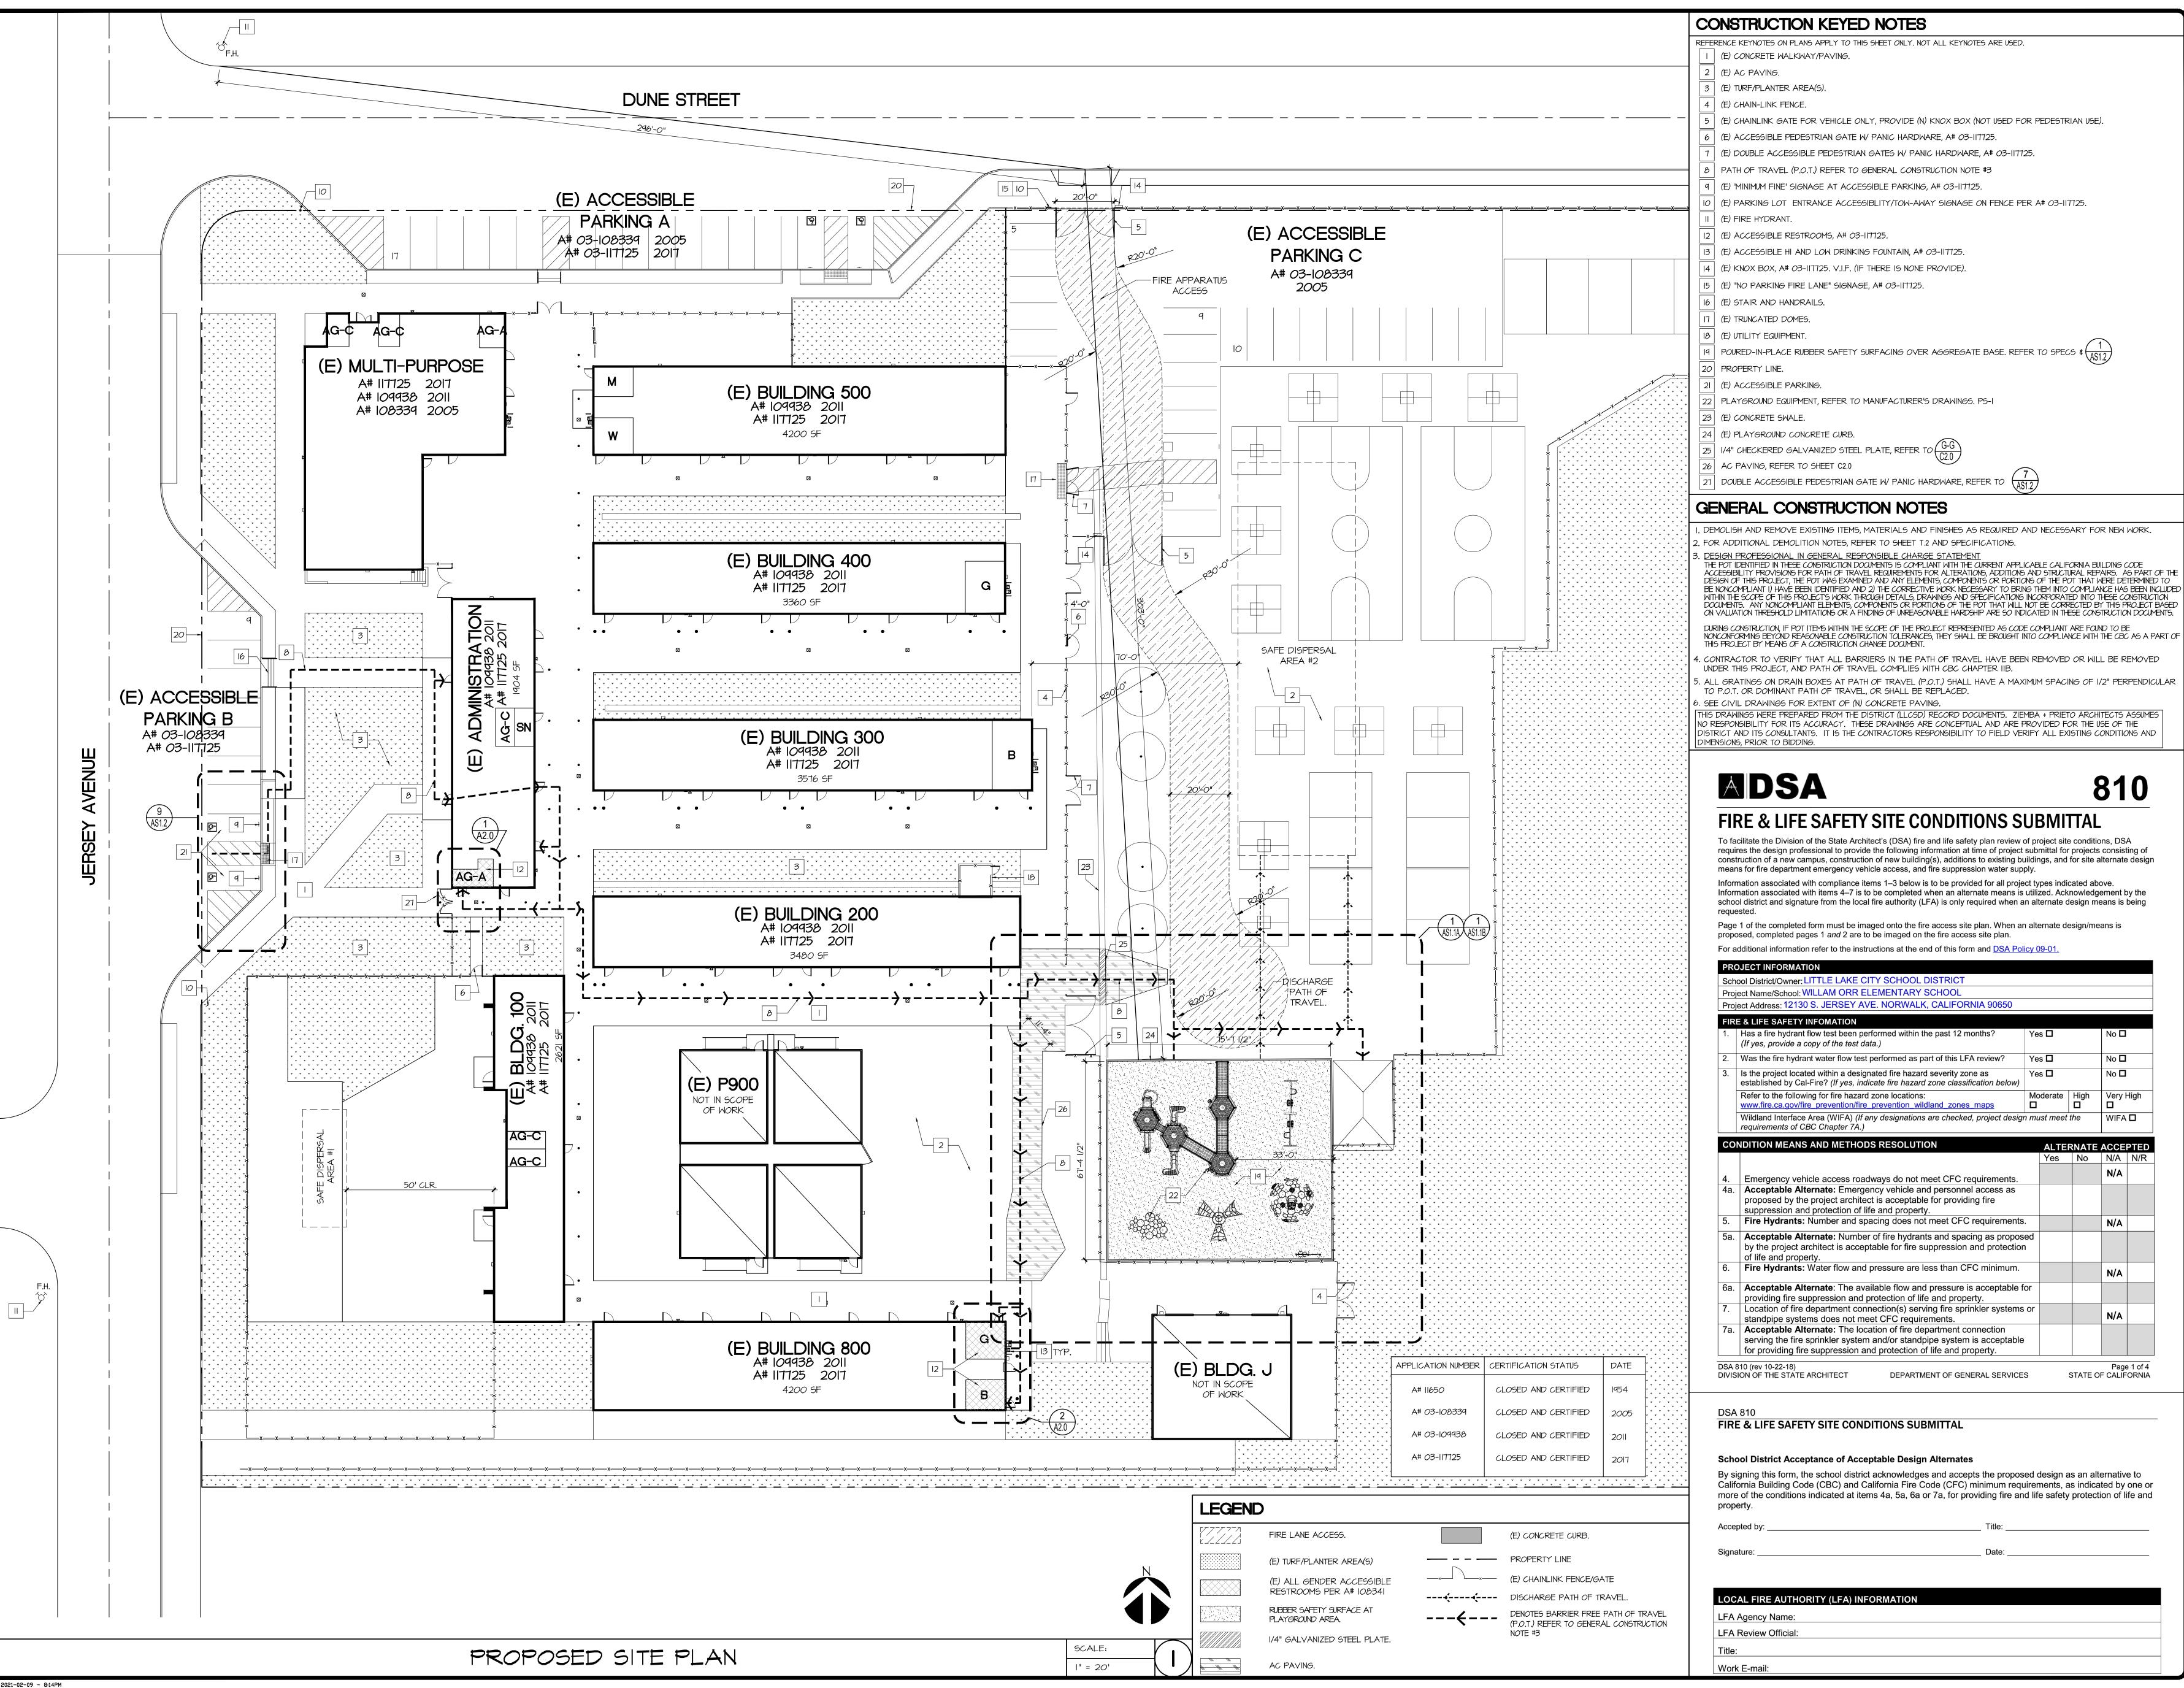



NO. DATE

01/15/2021 191201 JOB NO.: DRAWN BY:

CHECKED BY: JP

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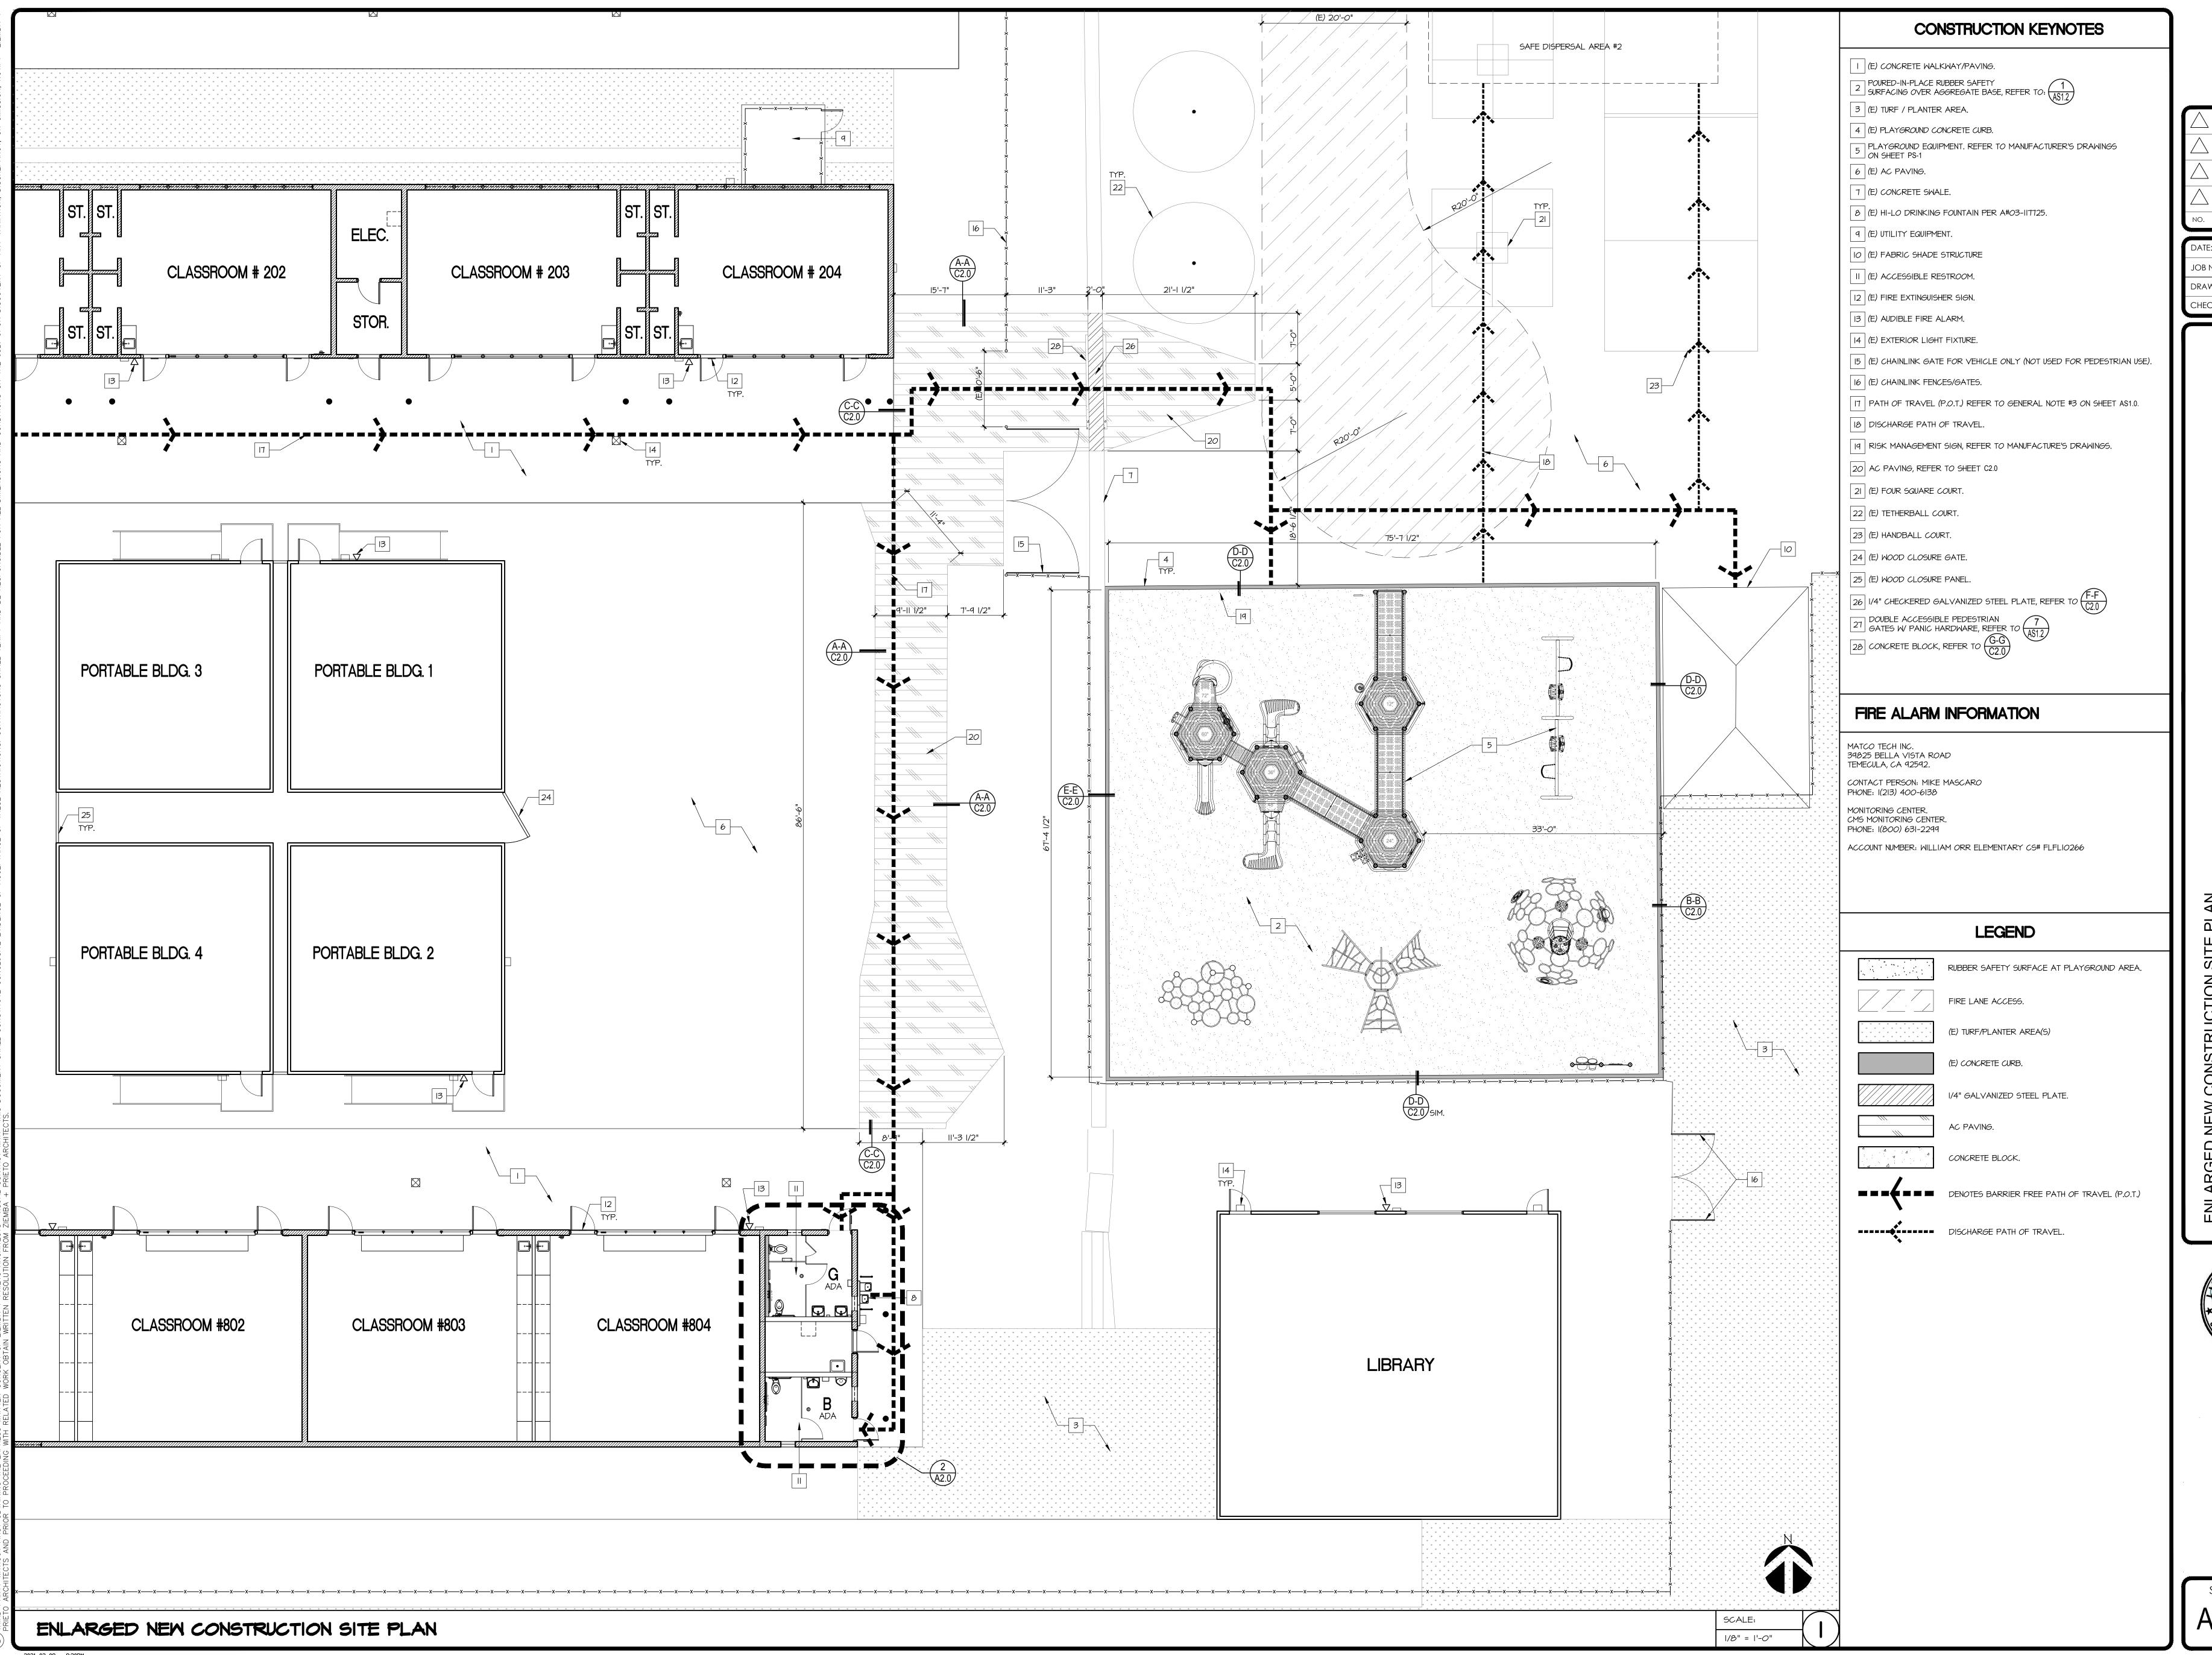


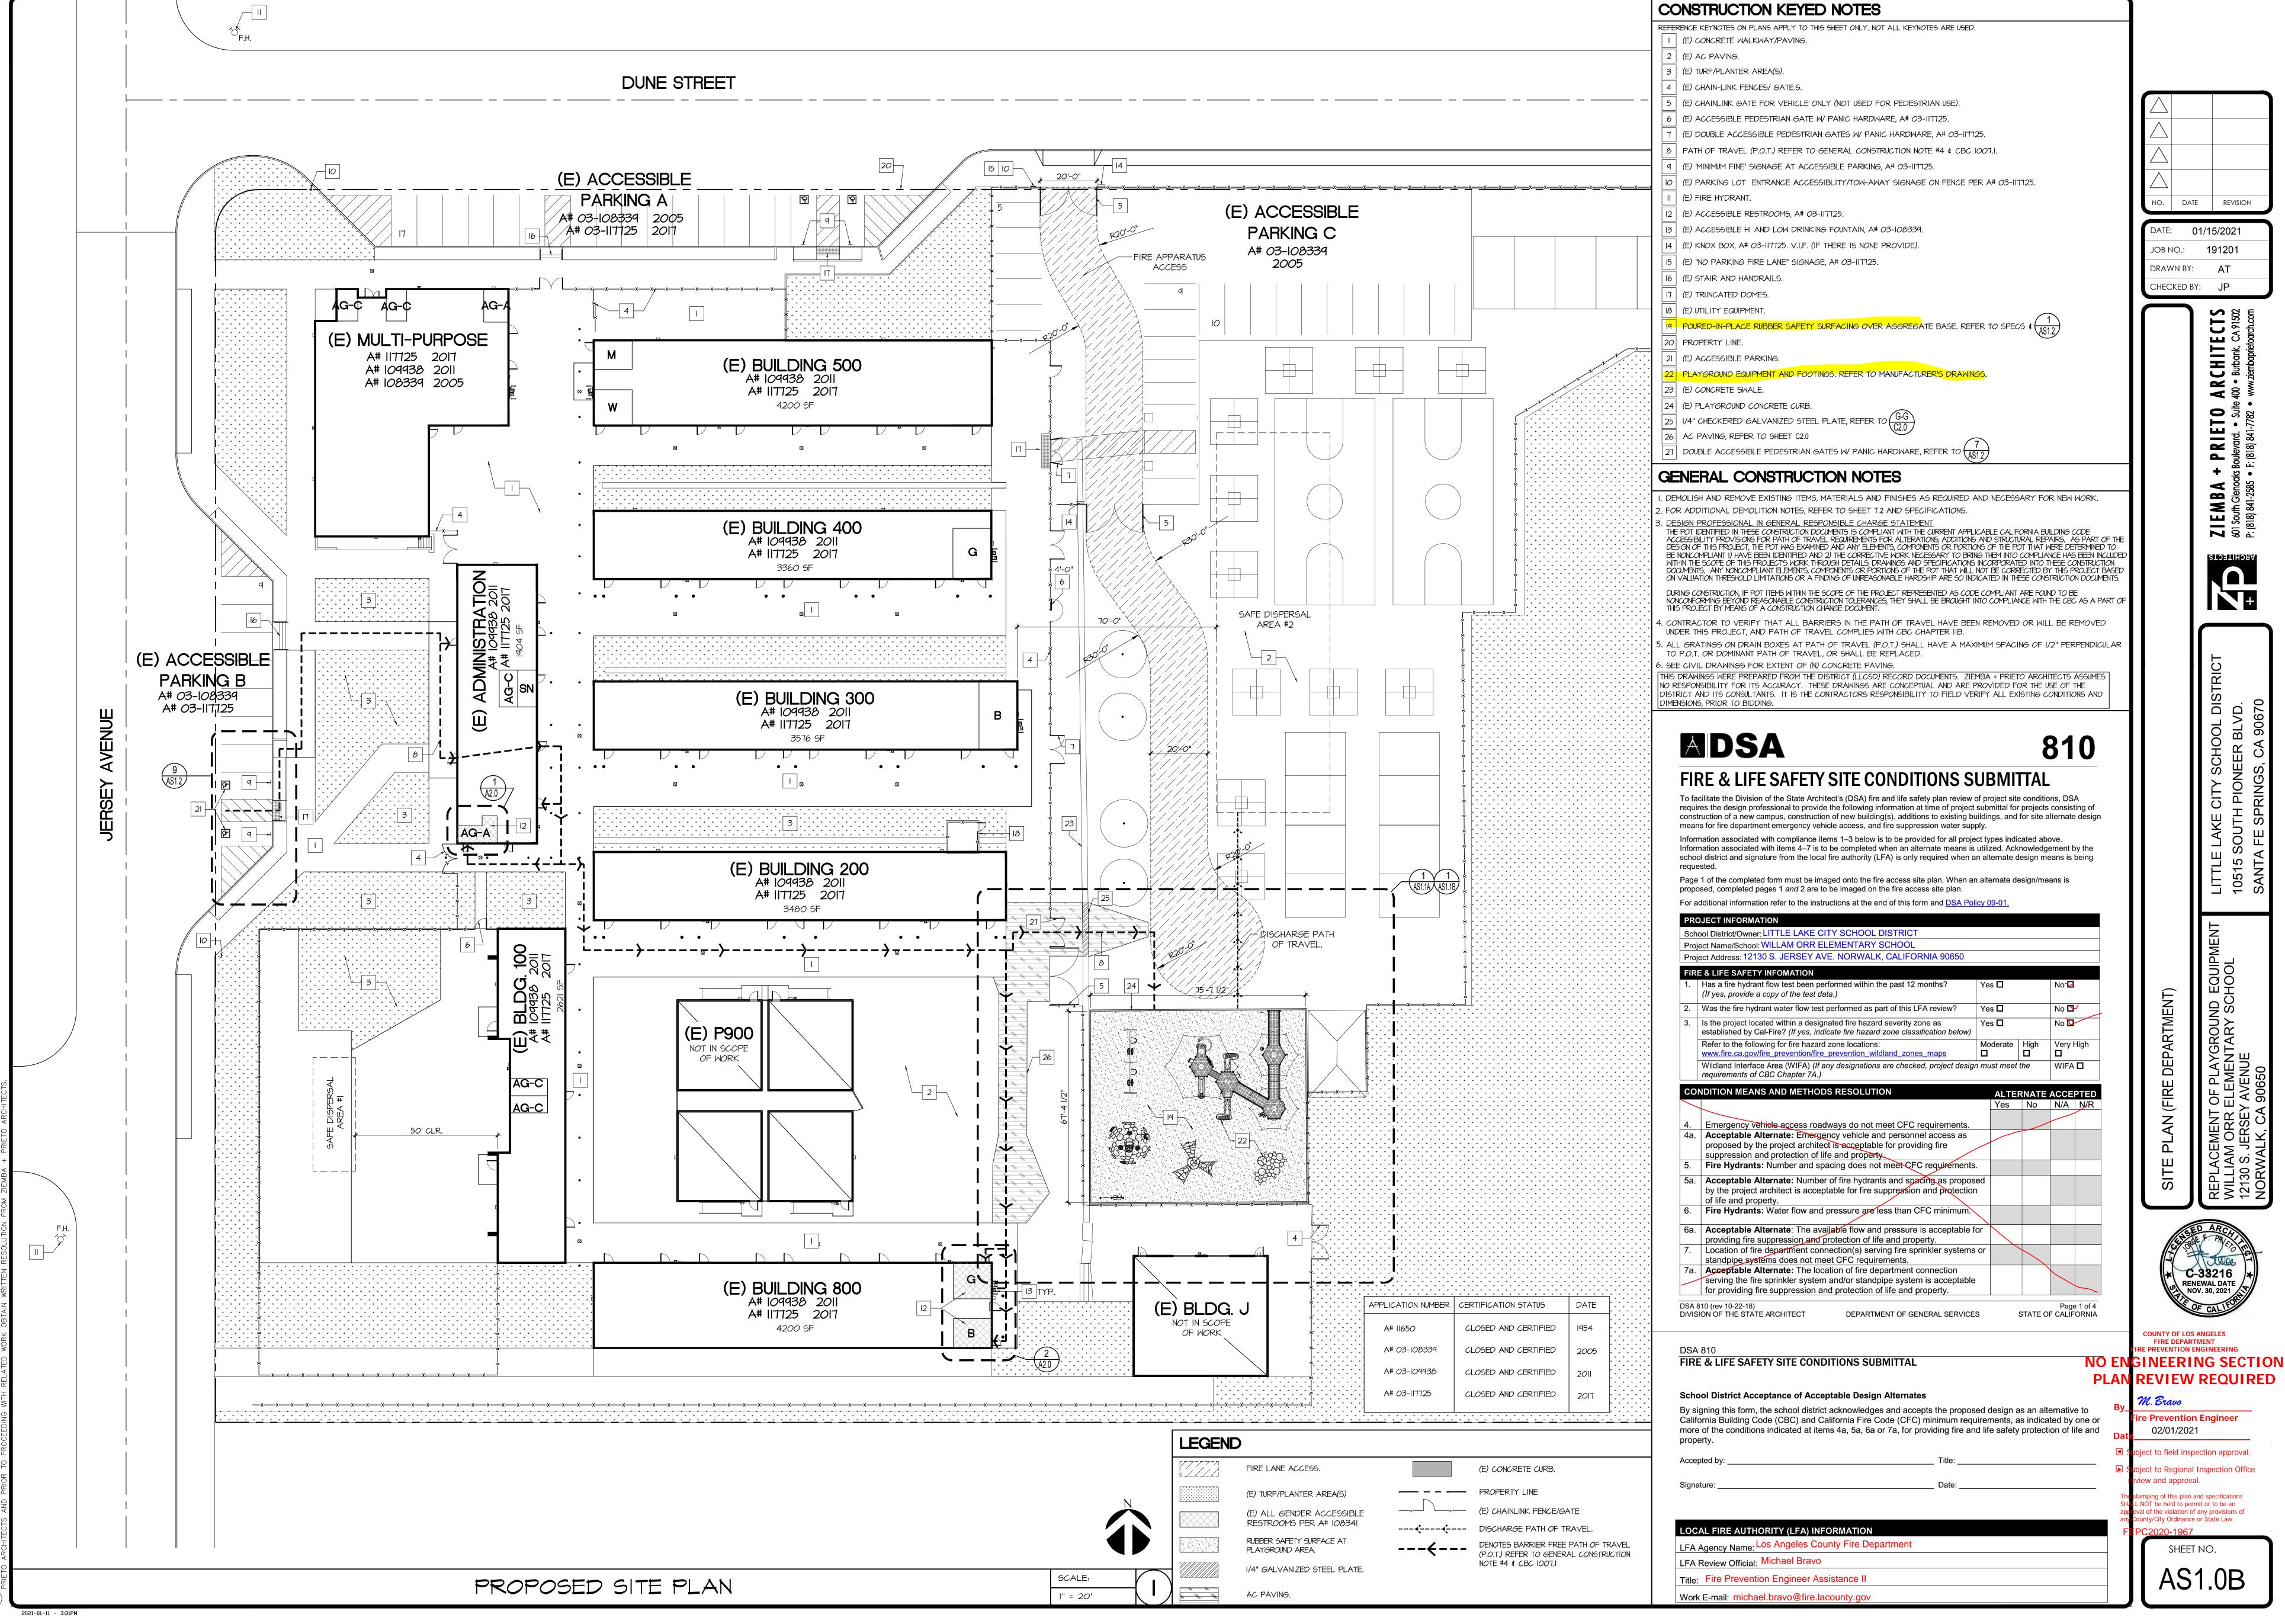

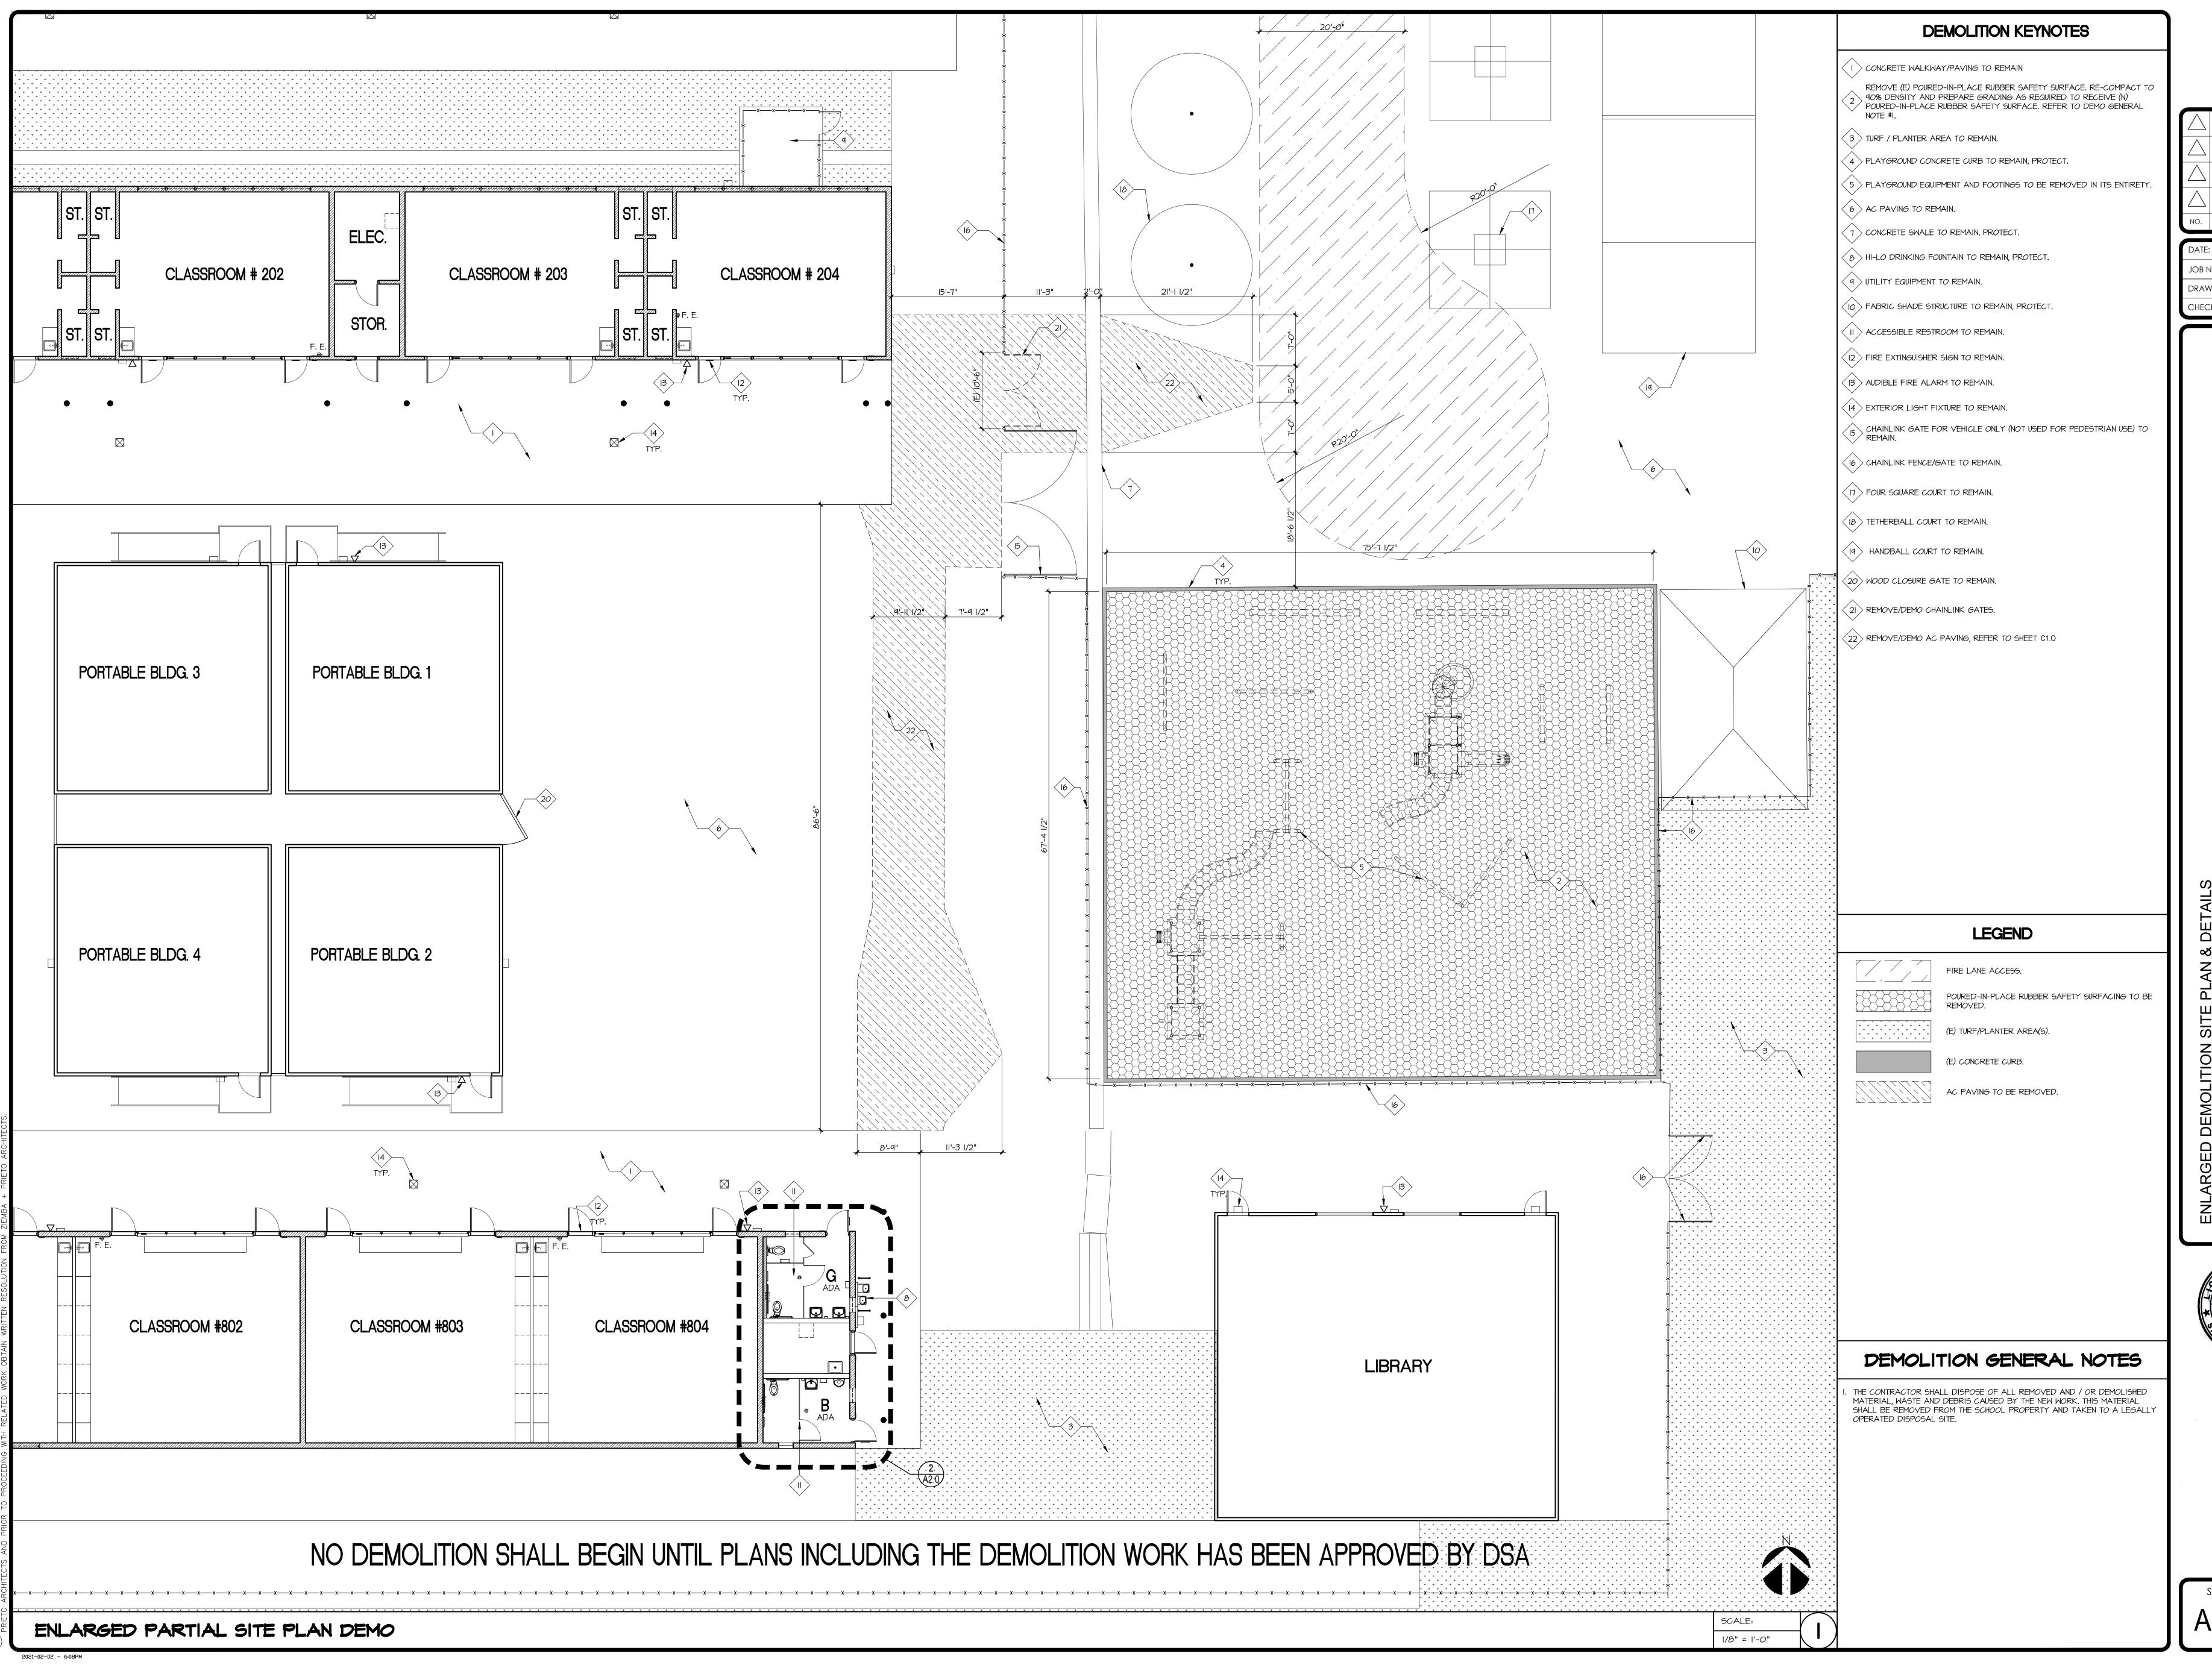NO. DATE REVISION

JOB NO.: **191201** DRAWN BY: AT CHECKED BY: JP






NO. DATE REVISION

01/15/2021 JOB NO.: 191201 DRAWN BY:

CHECKED BY: JP

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REVISED 4/28/09. SUCH CONDITIONS MUST BE CLEARLY DEMONSTRATED AND INDICATED IN THE SPECFICATIONS:

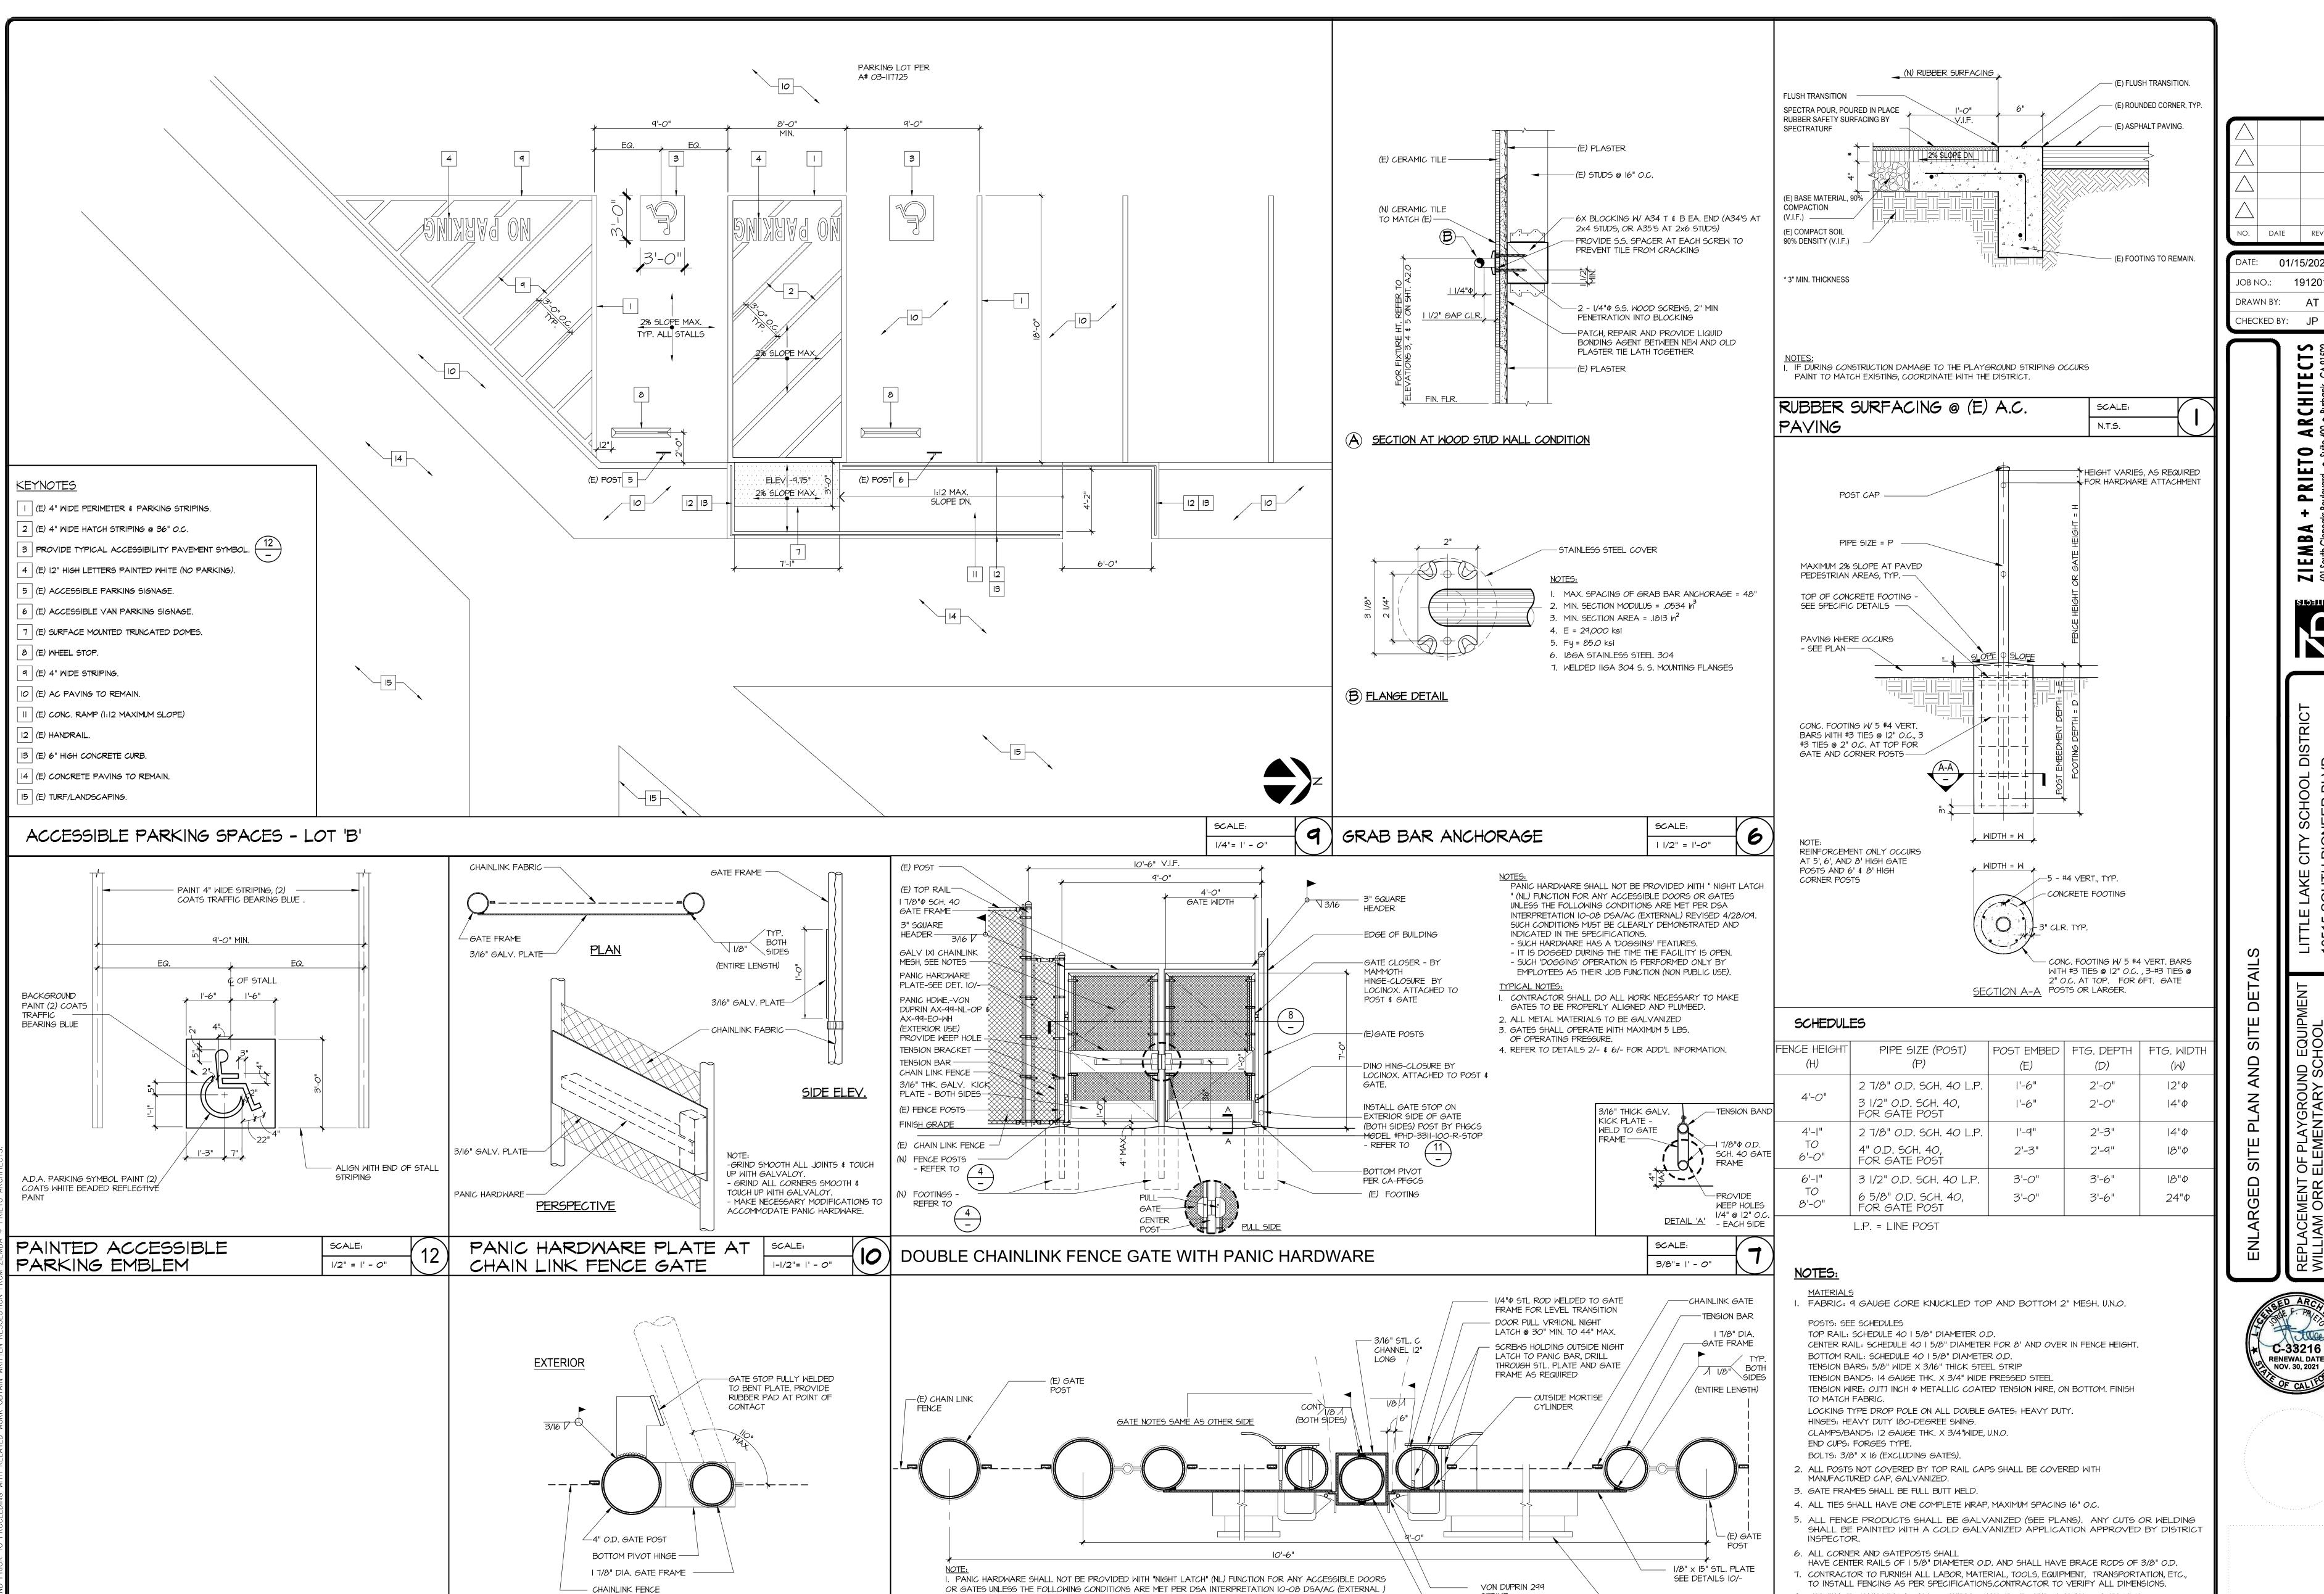C. SUCH "DOGGING" OPERATION IS PERFORMED ONLY BY EMPLOYEES AS THEIR JOB FUNCTION

A. SUCH HARDWARE HAS A "DOGGING" FEATURE.

(NON-PUBLIC USE).

3" = 1' - 0"

CHAINLINK GATE STOP

2021-02-09 - 8:52PM

B. IT IS DOGGED DURING THE TIME THE FACILITY IS OPEN.

CHAINLINK ACCESSIBLE DOUBLE GATE

2. DRILL WEEP HOLE AT BOTTOM OF PANIC HARDWARE FOR WATER DRAINAGE

O. DATE

01/15/2021 JOB NO.: DRAWN BY:

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8. TERMINATE CHAIN LINK AT ALL CORNERS, CHANGE OF DIRECTION AND GATES WITH TENSION BAR AND CLAMPS.

STRIKE

- 4" DIA. CENTER

PANIC HDWE.-VON DUPRIN

(EXTERIOR USE) PROVIDE


WEEP HOLE

3" = 1' - 0"

AX-99-NL-0P & AX-99-E0-WH

9. LATCH: FORGED TYPE CAPABLE OF RETAINING GATE IN CLOSED POSITION AND HAVE PROVISION FOR PADLOCK. LATCH SHALL PERMIT OPERATION FROM EITHER SIDE OF THE GATE (U.N.O.). 10. PROVIDE CANE BOLTS ON 20'-0" WIDE GATE (BOTH LEAFS) WITH GALV. INSERT IN PAVING


CHAIN LINK FENCING 1/2"= 1' - 0"

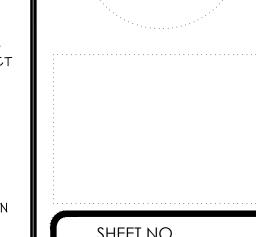

SHEET NO.

C-33216

RENEWAL DATE NOV. 30, 2021

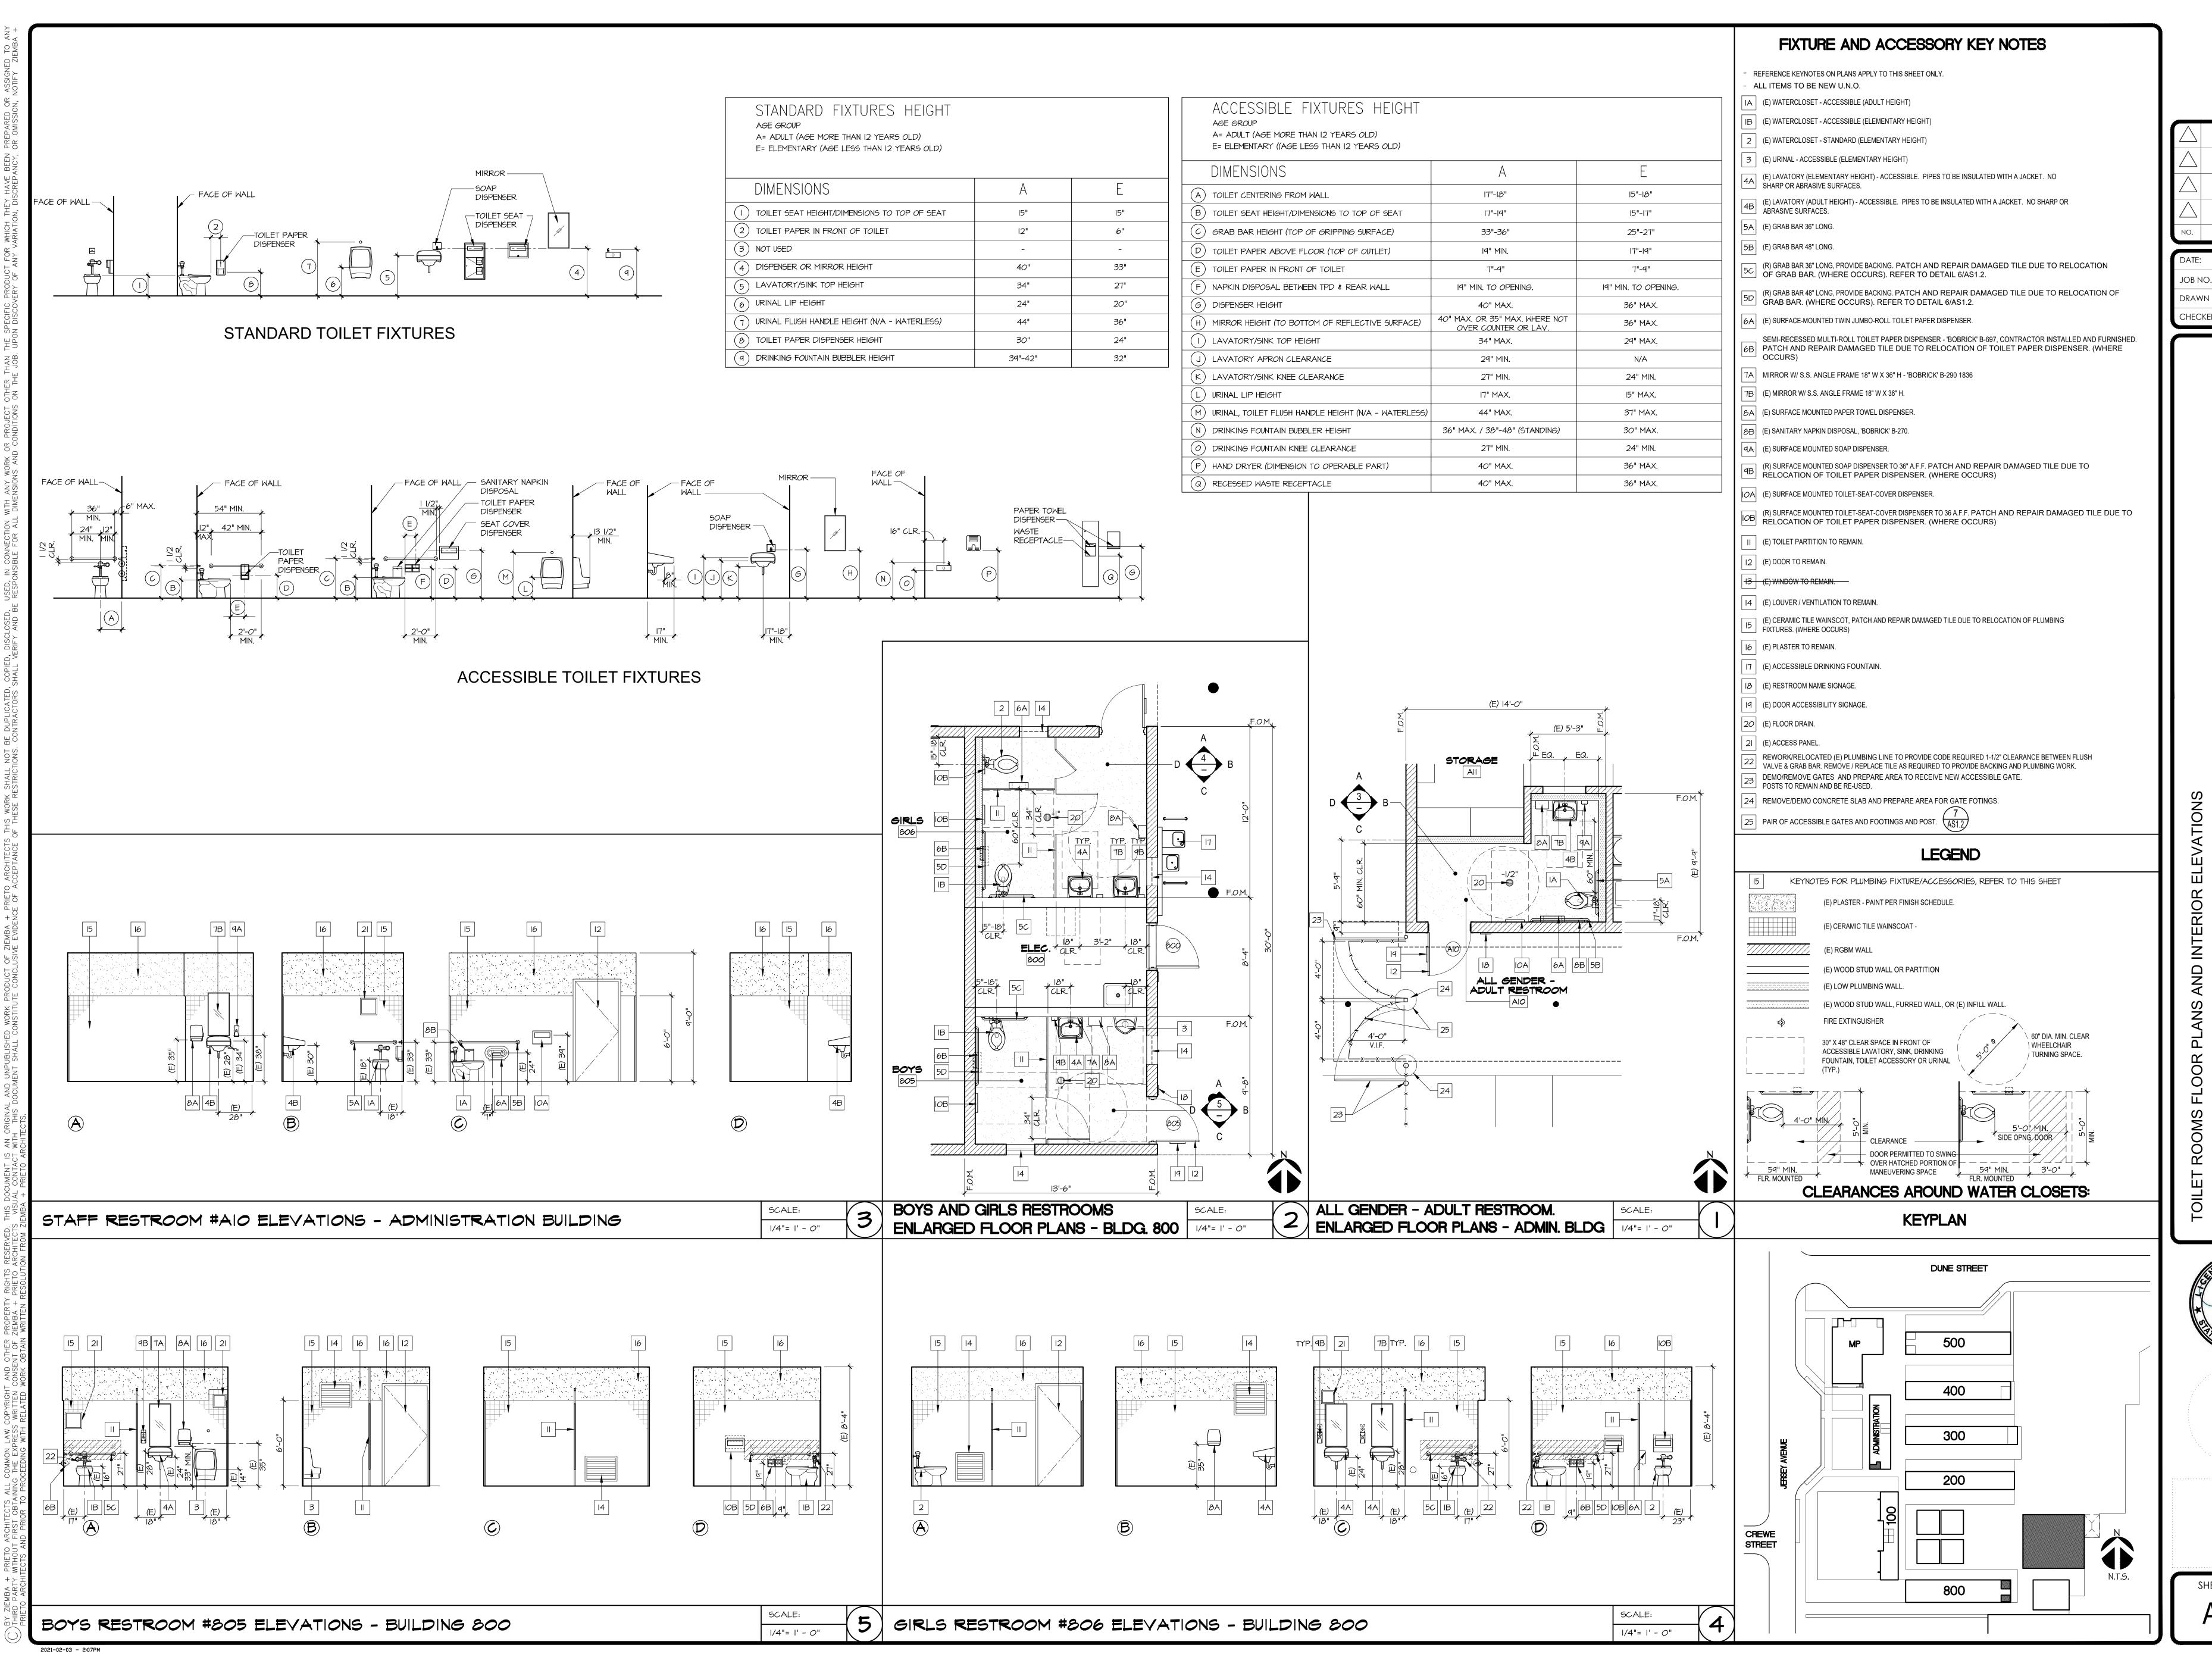

NO. DATE REVISION


DATE: 01/15/2021 JOB NO.: 191201 DRAWN BY: AT

CHECKED BY: JP

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SHEET NO.



PLAY STRUCTURE AND LAYOUT OF THE COMPONENTS CONFORM TO ASTM F1487-17 AND CPSC #325 GUIDELINES AND CCR TITLE 22, DIVISION 4 CHAPTER 22.

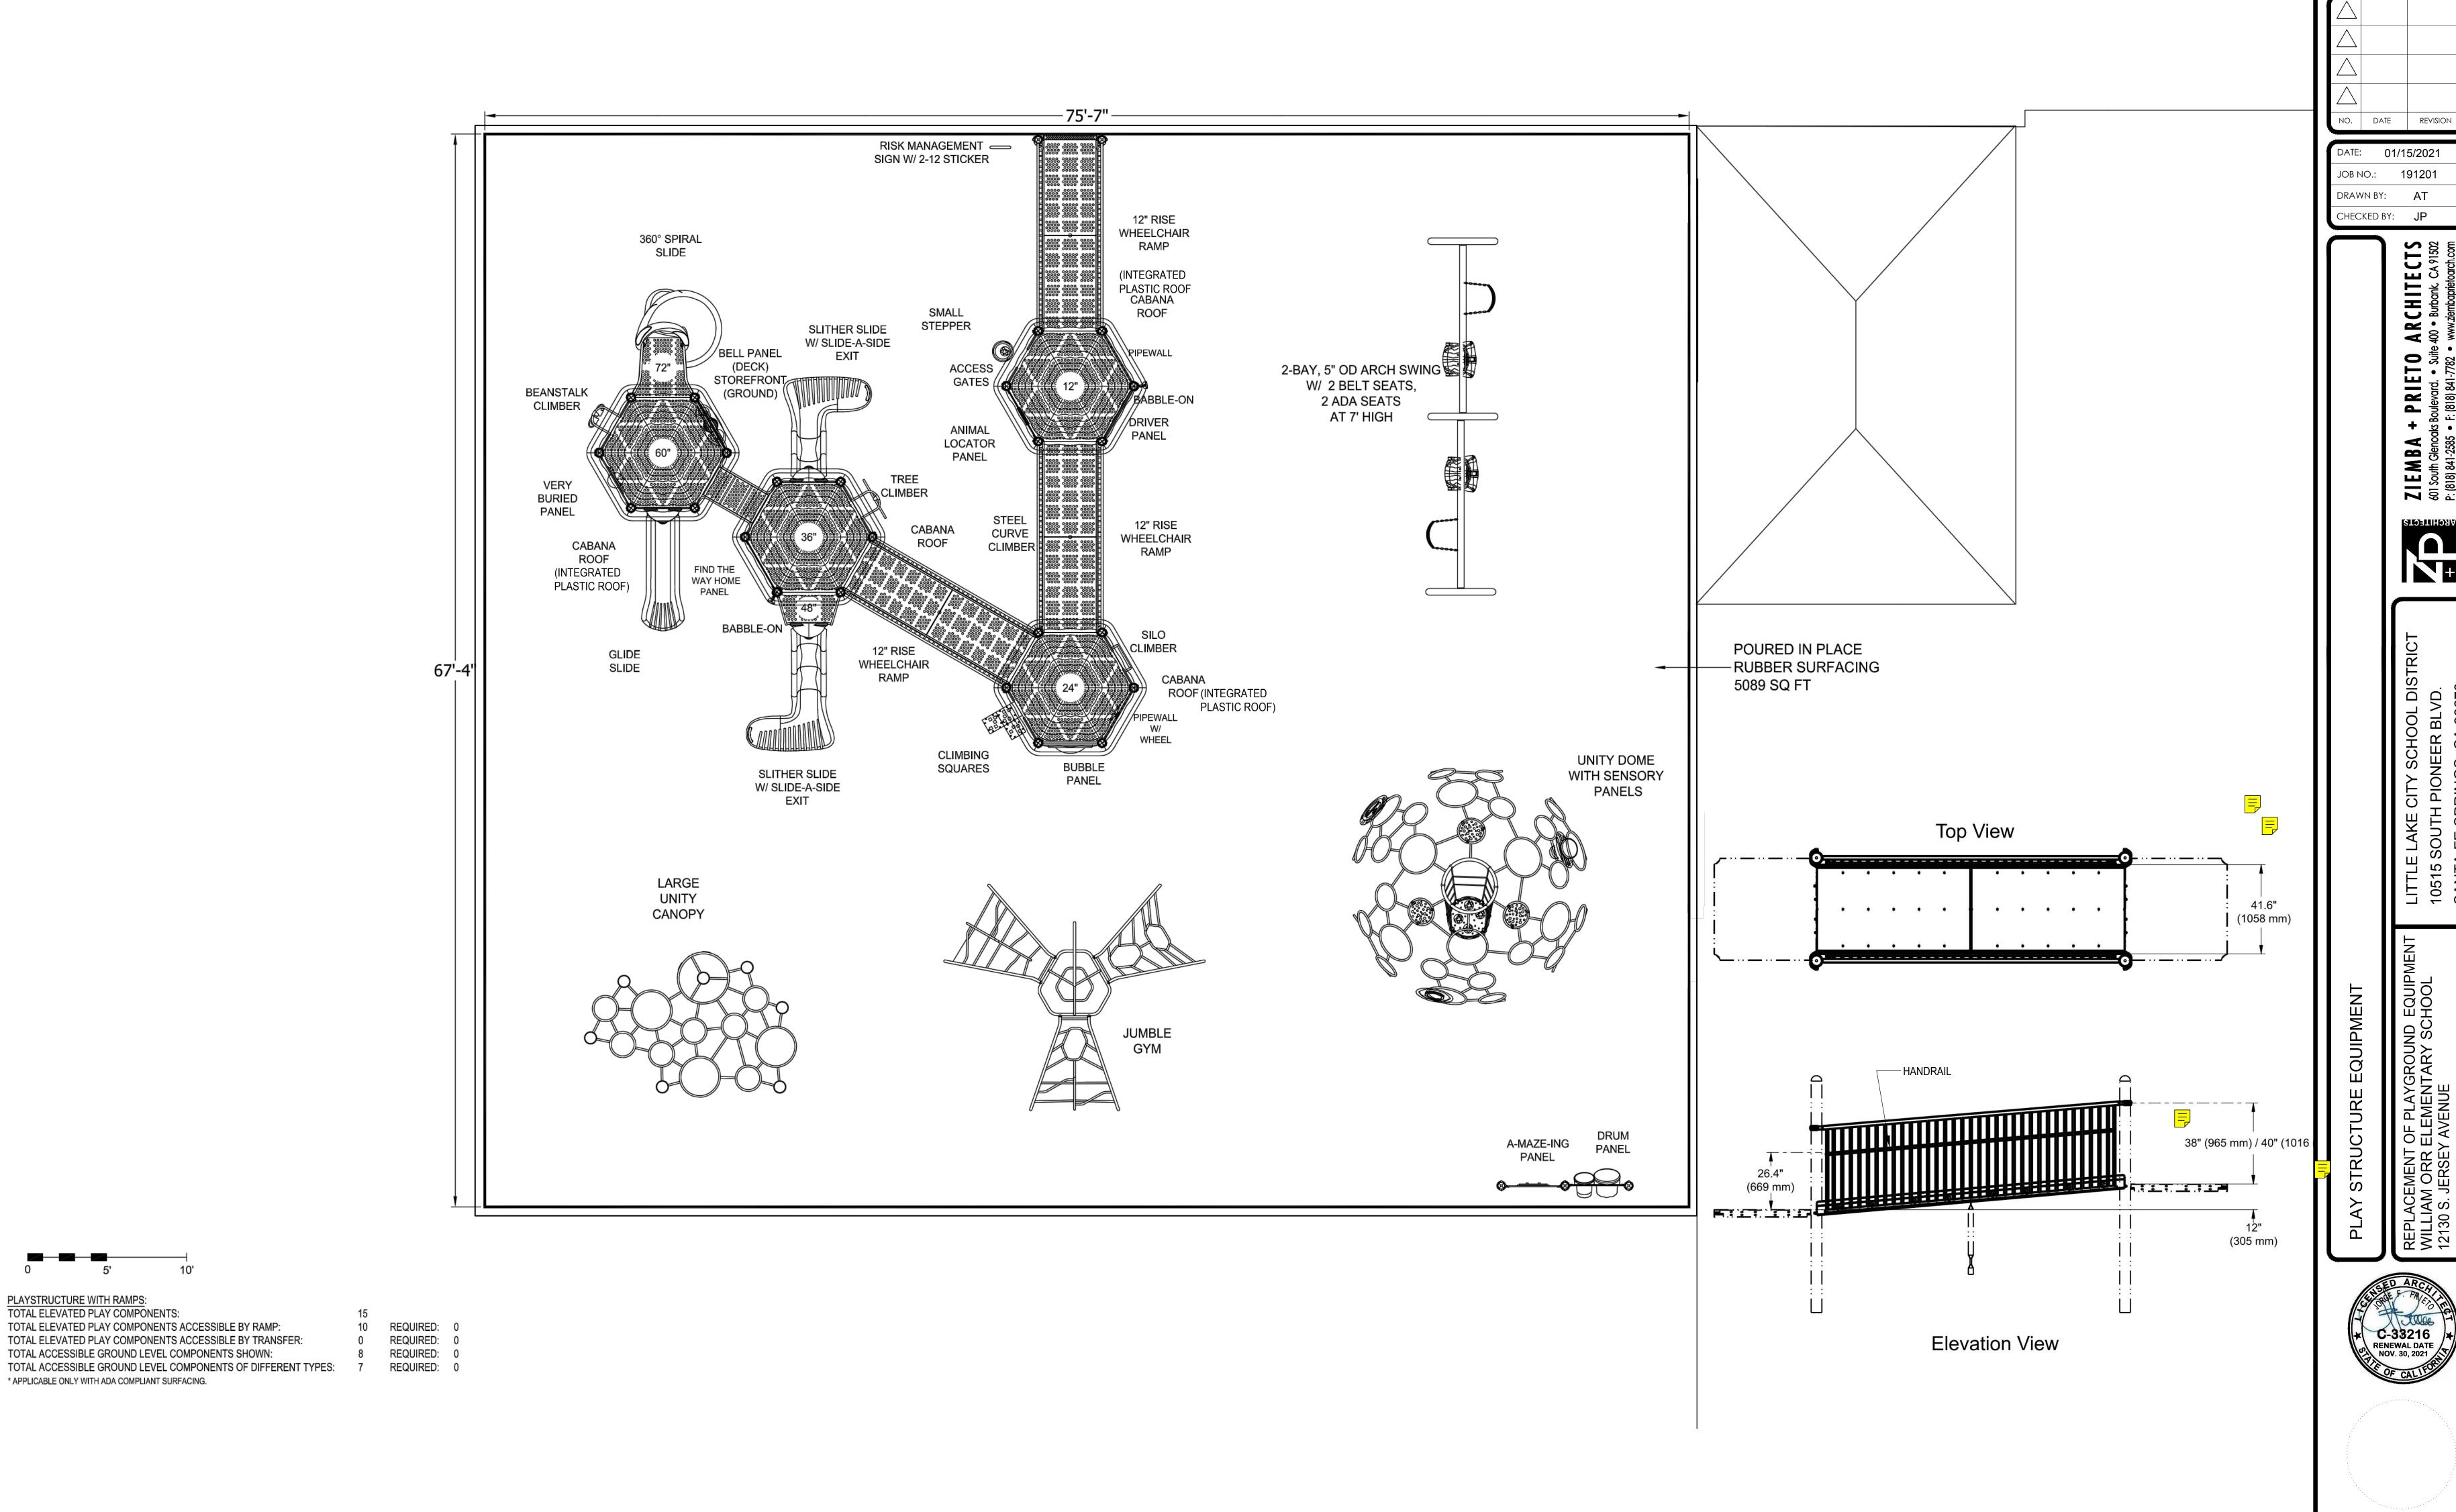PLAYSTRUCTURE WITH RAMPS:
TOTAL ELEVATED PLAY COMPONENTS:

* APPLICABLE ONLY WITH ADA COMPLIANT SURFACING.

TOTAL ELEVATED PLAY COMPONENTS ACCESSIBLE BY RAMP:

TOTAL ACCESSIBLE GROUND LEVEL COMPONENTS SHOWN:


CRITICAL FALL HEIGHT OF OVERALL PLAY AREA: 96"

PROJECT:

WILLIAM ORR SANTA FE SPRINGS, CA - OPTION 4 DESIGNED BY:
BRITTANY PULKRABEK **FEBRUARY 9, 2021** DRAWING # C20078PMR9

DESIGNED FOR AGES



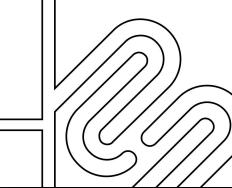

PS-1