



LAKE CENTER MIDDLE SCHOOL

OVERALL SITE PLAN

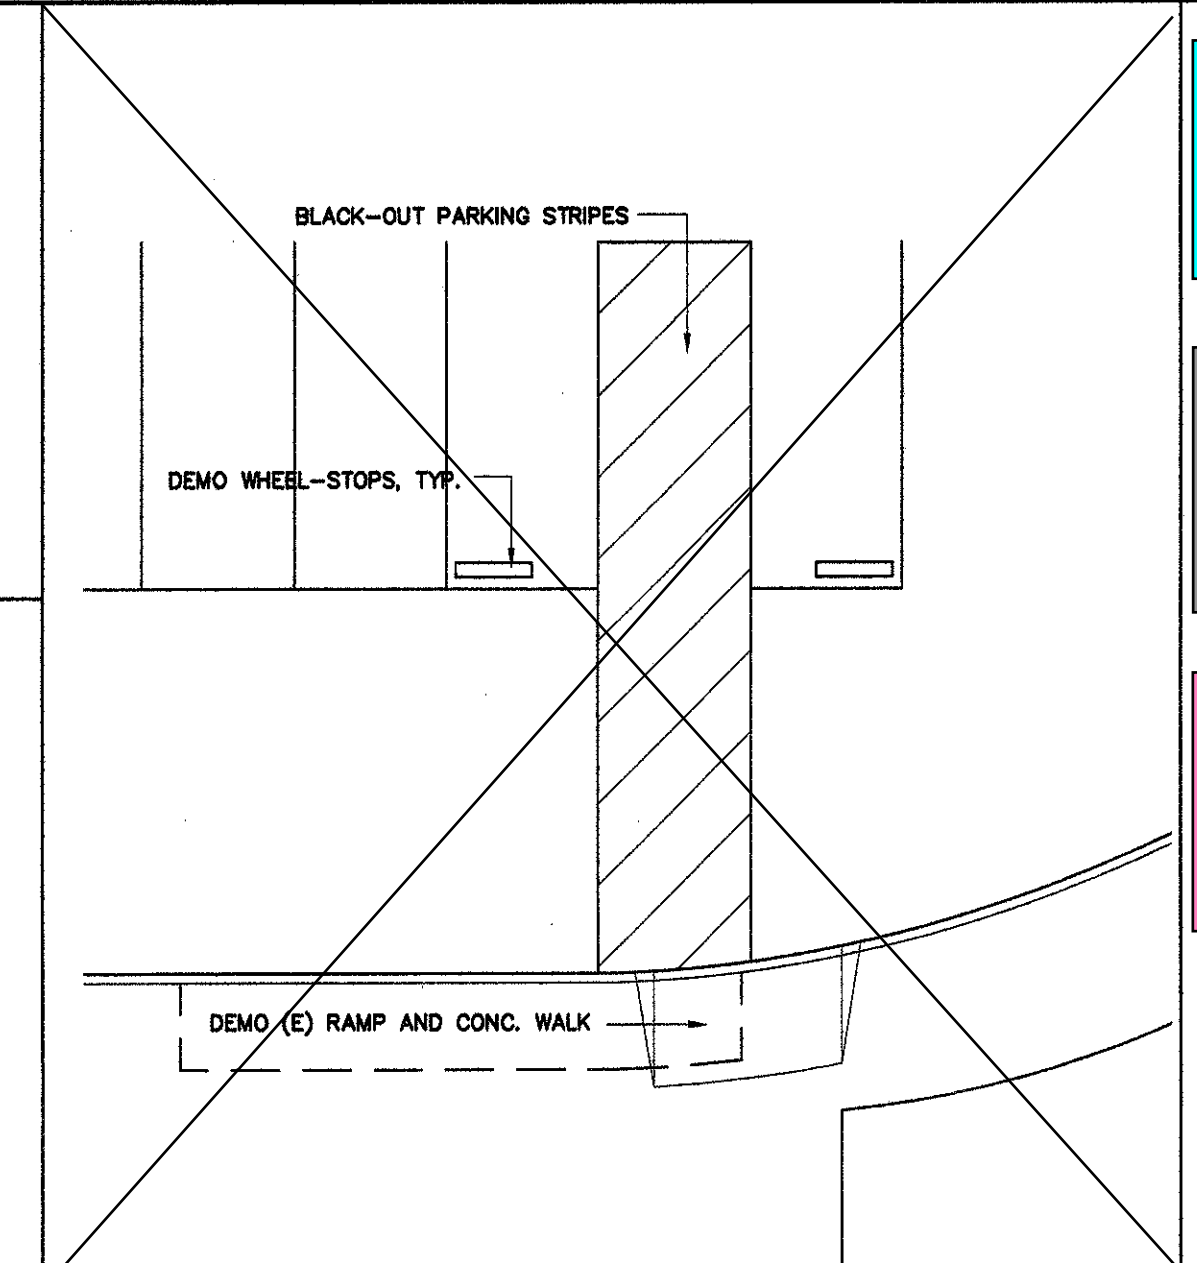

DEMO PARKING PLAN 1"=10'-0" 1

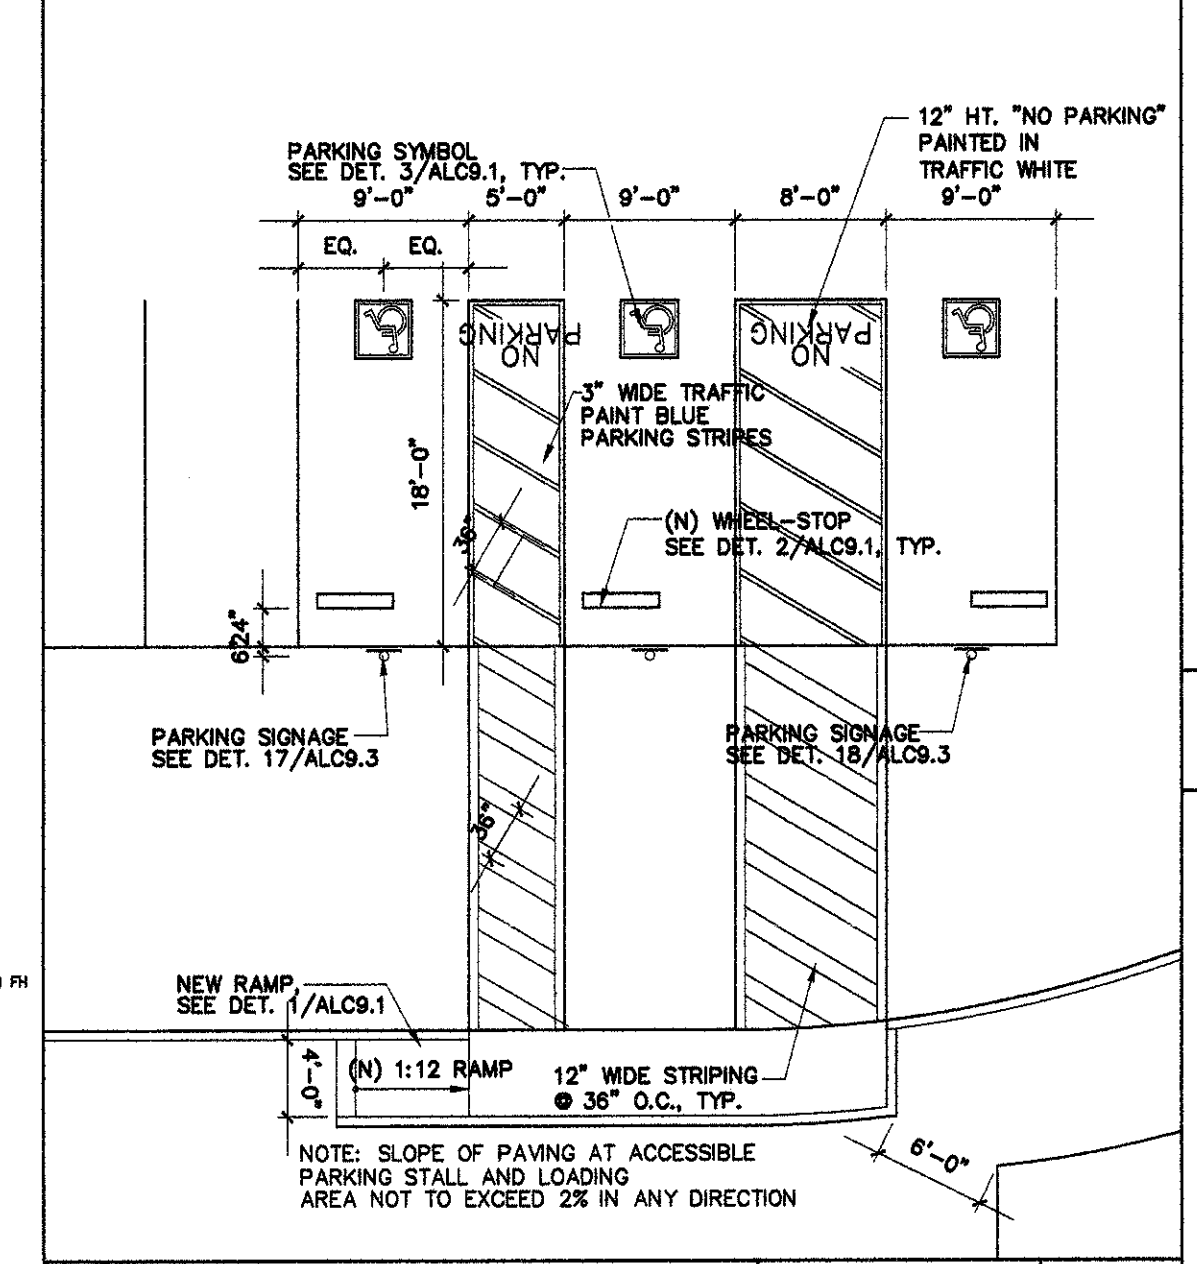

NEW PARKING PLAN 1"=10'-0" 2

1. DEMO / INSTALL APPROX: 50,000' SQFT OF AC PAVING (N) 4" AC PAVING OVER 4" BASE COMPACTED TO 90%. (N) WHEEL STOPS AND (N) PARKING STALL STRIPING TO MATCH (E) PARKING STALL LAYOUT OR AS DIRECTED BY DISTRICT / CM. (N) SEAL COAT THROUGHOUT.

2. GRUB / EXPORT / OVER-X 6" AND PREP FOR APPROX: 17,000' SQFT OF NEW 6" AC PAVING OVER 4" BASE COMPACTED TO 90%. (N) RED WOOD HEADERS WHERE AC PAVING MEETING LANDSCAPING. (N) PARKING STALL STRIPING W/ (N) WHEEL STOPS TO ACCOMMODATE 25 (N) PARKING STALLS. (N) SEAL COAT THROUGHOUT.

3. DEMO / INSTALL APPROX: 64,500' SQFT OF AC PAVING. INSTALL (N) 6" AC PAVING OVER 4" BASE COMPACTED TO 90%. (N) WHEEL STOPS AND (N) PARKING STALL STRIPING LAYOUT TO MATCH (E) OR AS DIRECTED BY DISTRICT / CM. (N) SEAL COAT THROUGHOUT.

REFERENCE NOTES

LEGEND

| | |
|--|-----------------------|
| | RESTROOMS |
| | SCOPE OF WORK |
| | EXISTING FIRE HYDRANT |

LEGEND


PATH OF TRAVEL

| TOTAL PARKING SPACES = 69 | STALL TYPE | | | |
|---|------------|------------|---|----|
| | STANDARD | ACCESSIBLE | | |
| ACCESSIBLE PARKING SPACE REQ'D (2001 CBC TABLE 11B-6) = 3 | | | | |
| | 66 | 2 | 1 | 69 |

PATH OF TRAVEL

| TOTAL PARKING SPACES = 69 | STALL TYPE | | | |
|---|------------|------------|---|----|
| | STANDARD | ACCESSIBLE | | |
| ACCESSIBLE PARKING SPACE REQ'D (2001 CBC TABLE 11B-6) = 3 | | | | |
| | 66 | 2 | 1 | 69 |

PARKING TABULATION

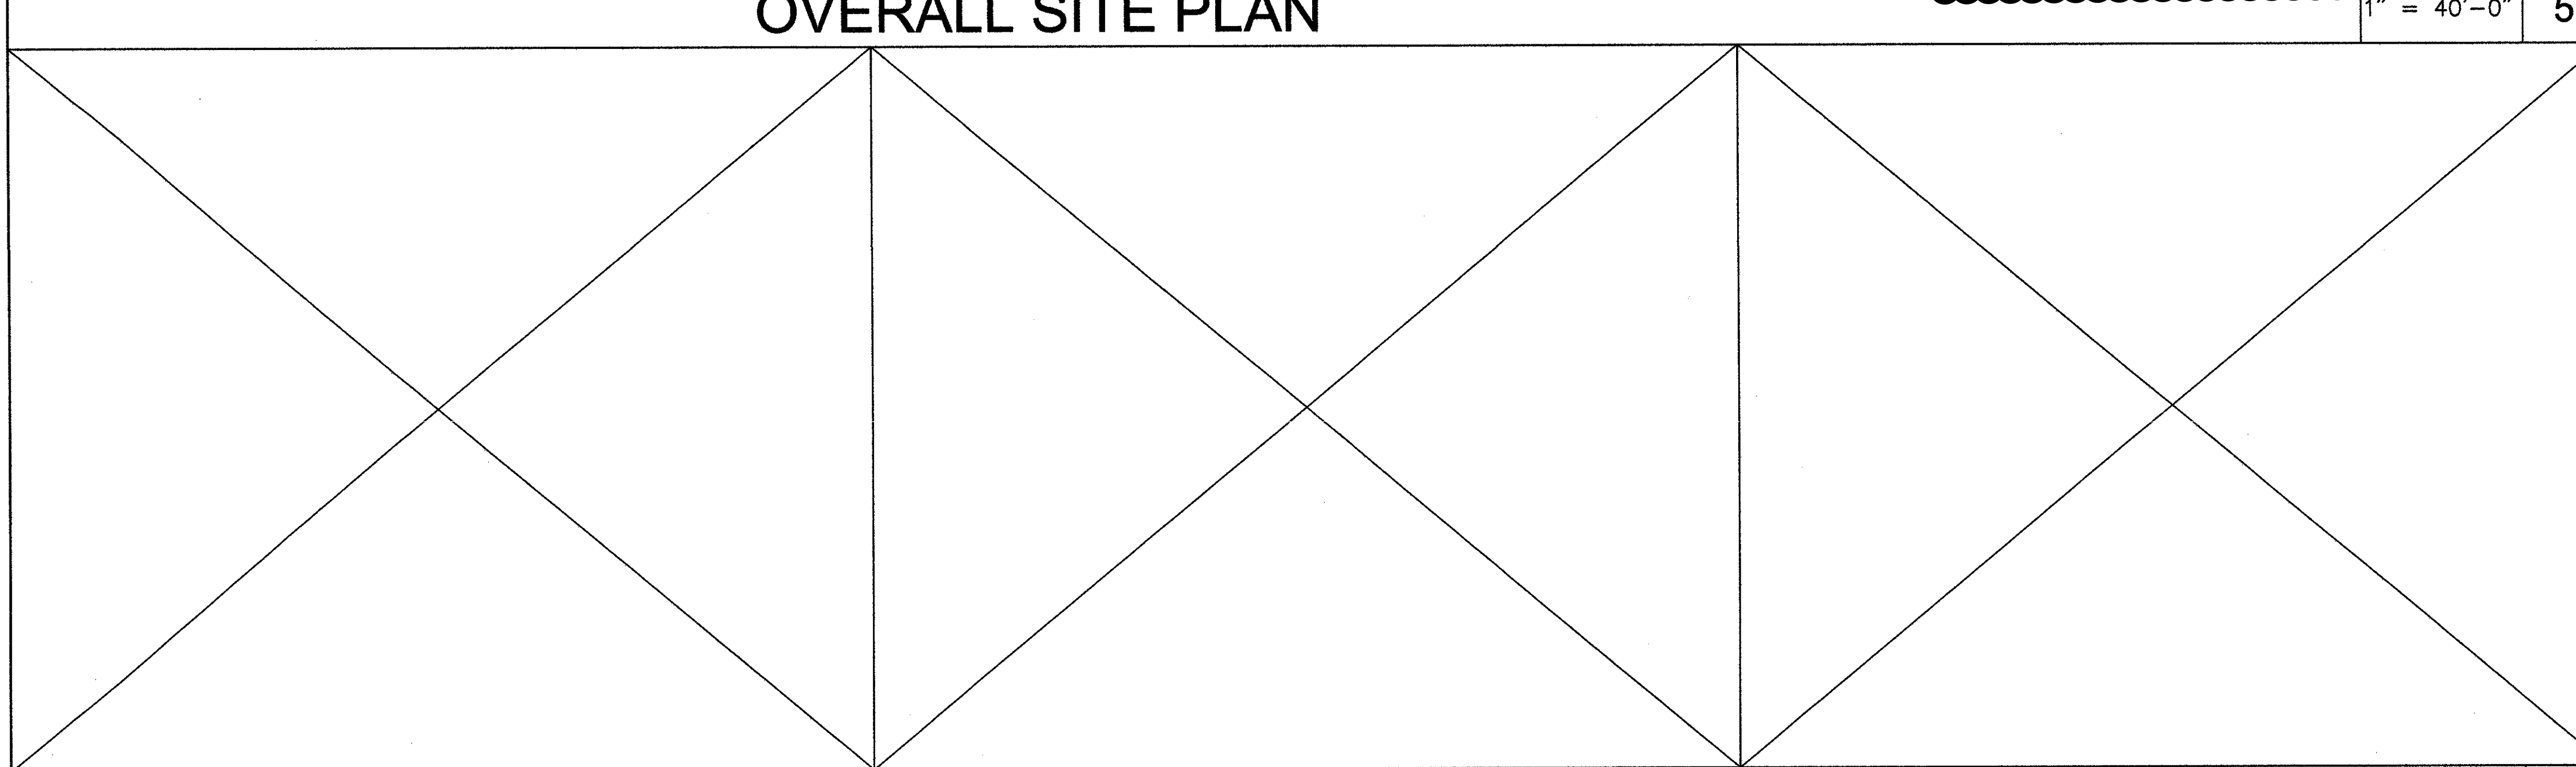


NOT USED 8 NOT USED 7 NOT USED 6 NOT USED 3"=1'-0" 4

2023 PAVING
LAKE CENTER MS / DISTRICT OFFICE
 10503 PIONEER BLVD
 SANTA FE SPRINGS CA, 90670
 10515 PIONEER BLVD
 SANTA FE SPRINGS CA, 90670


OVERALL SITE PLAN

DRAWING NUMBER : **ALC1.1**

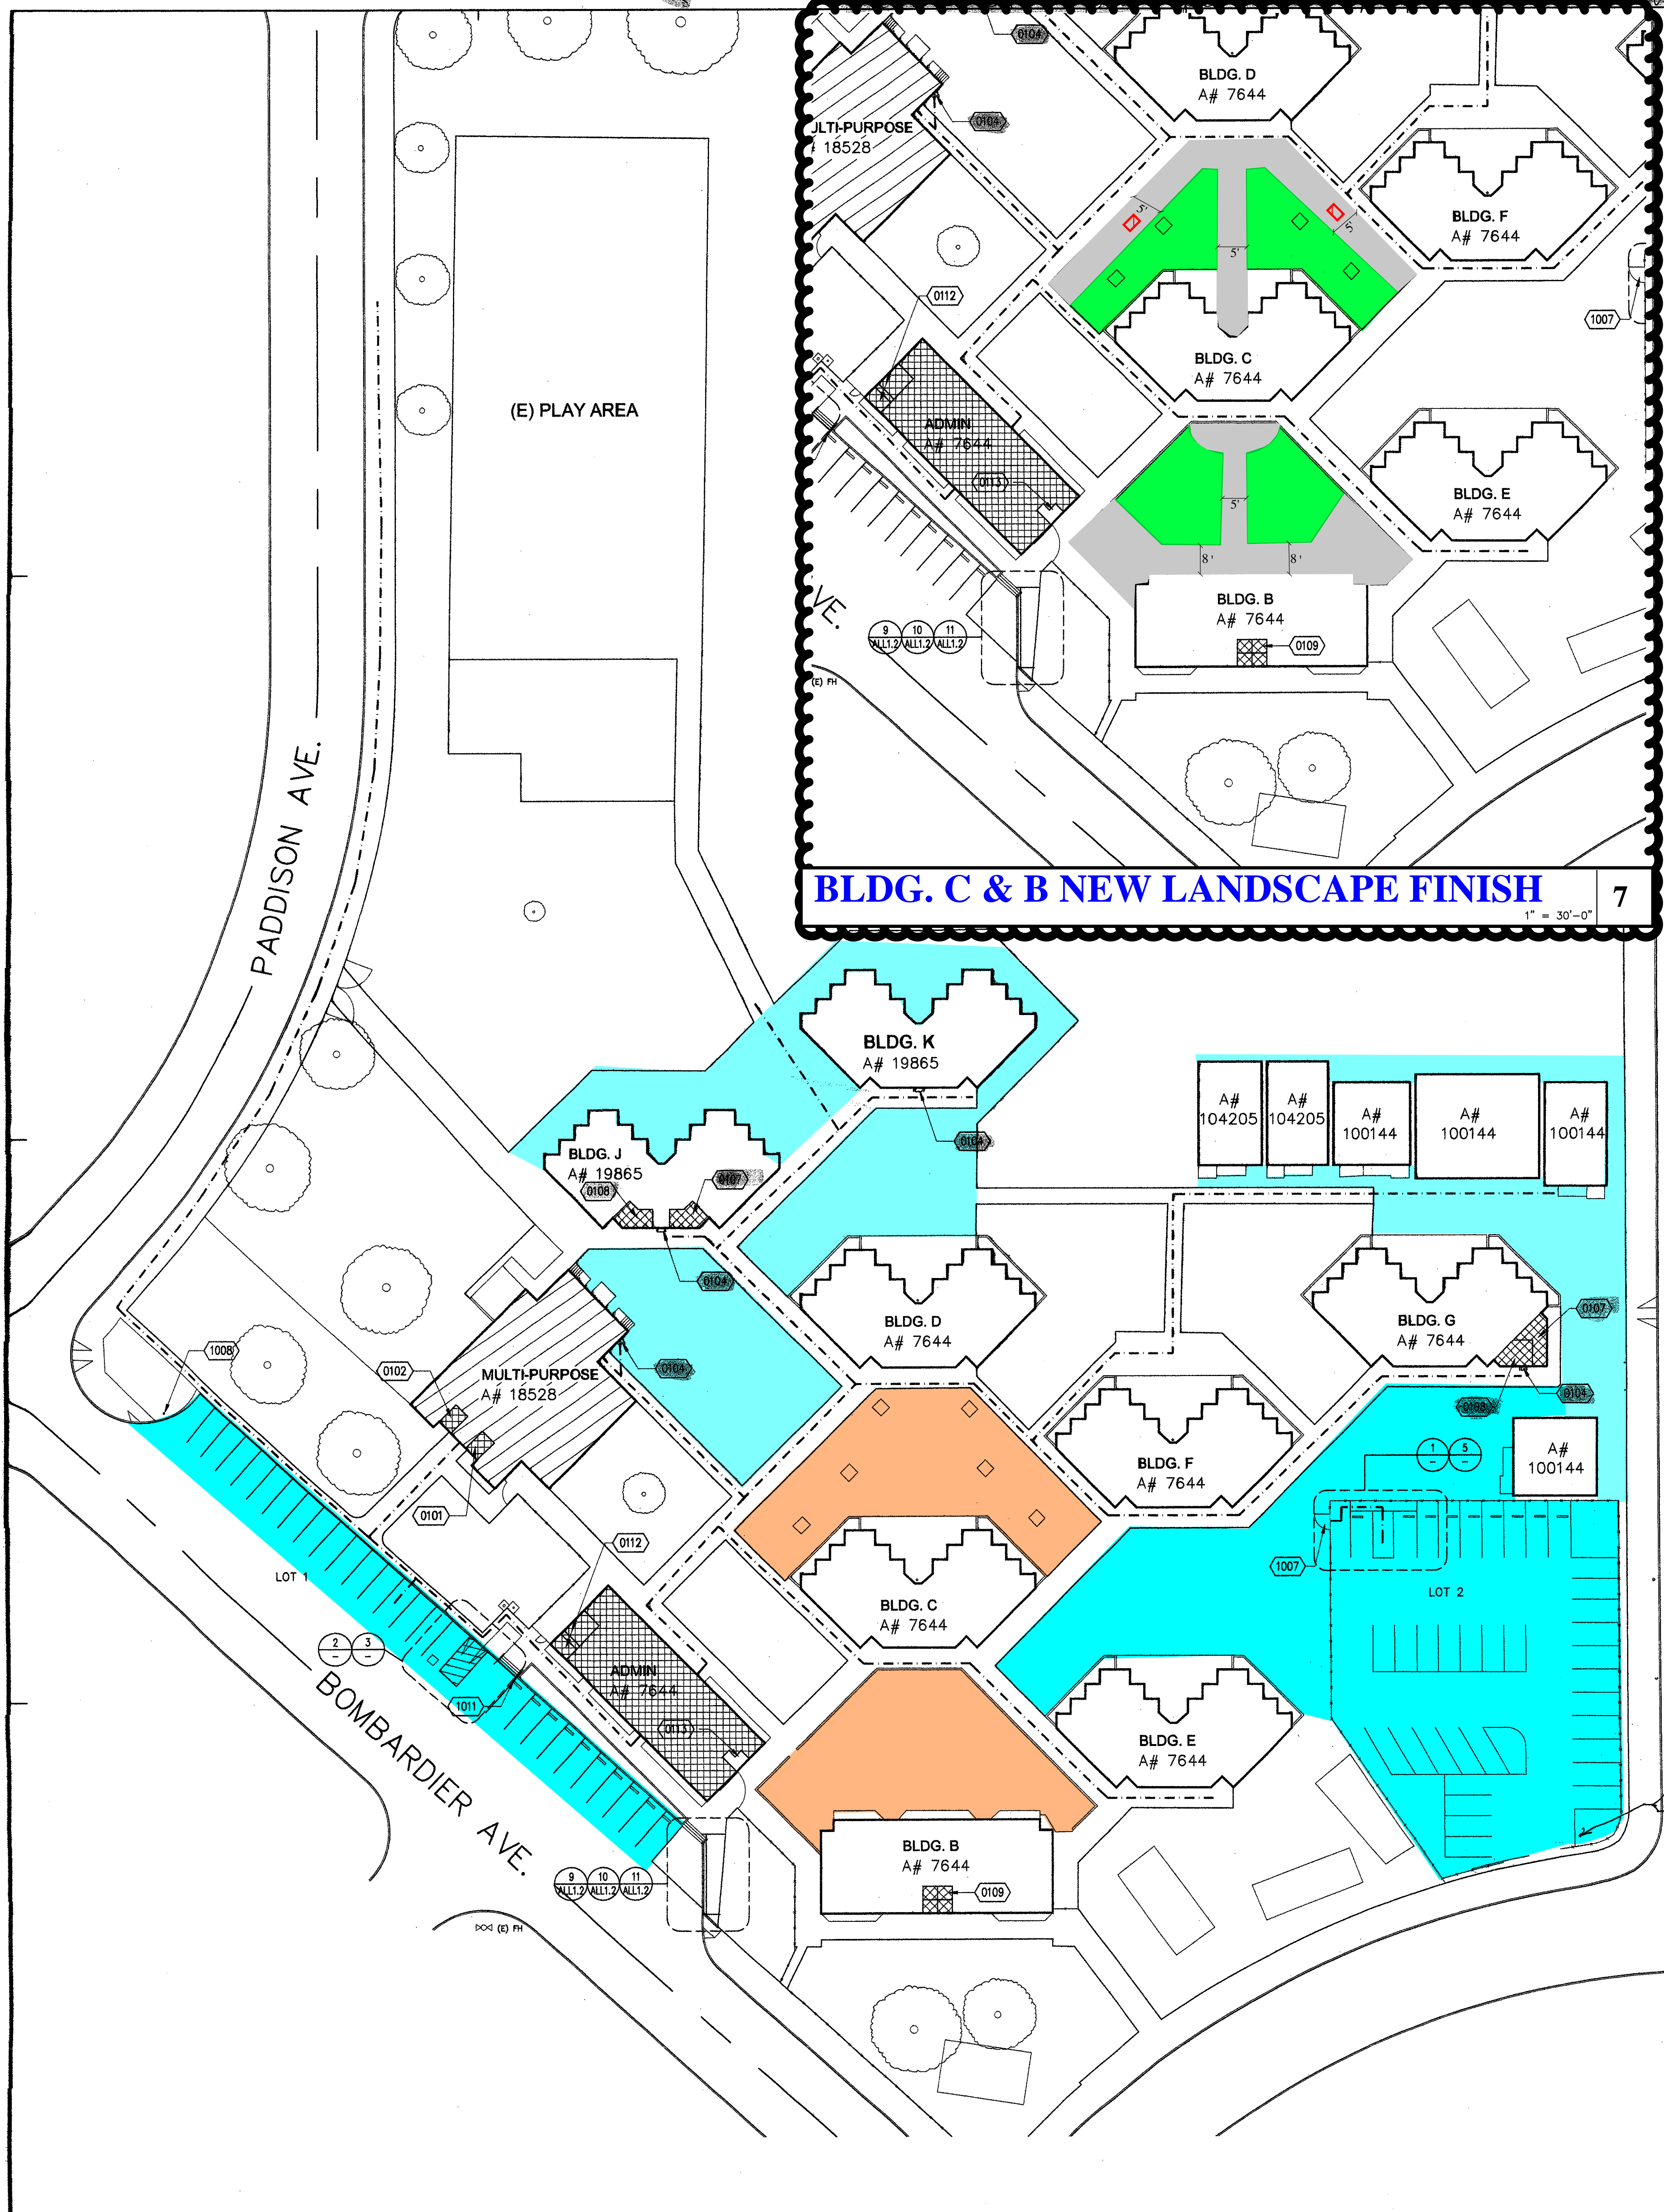


OVERALL SITE PLAN


1" = 30'-0" 6

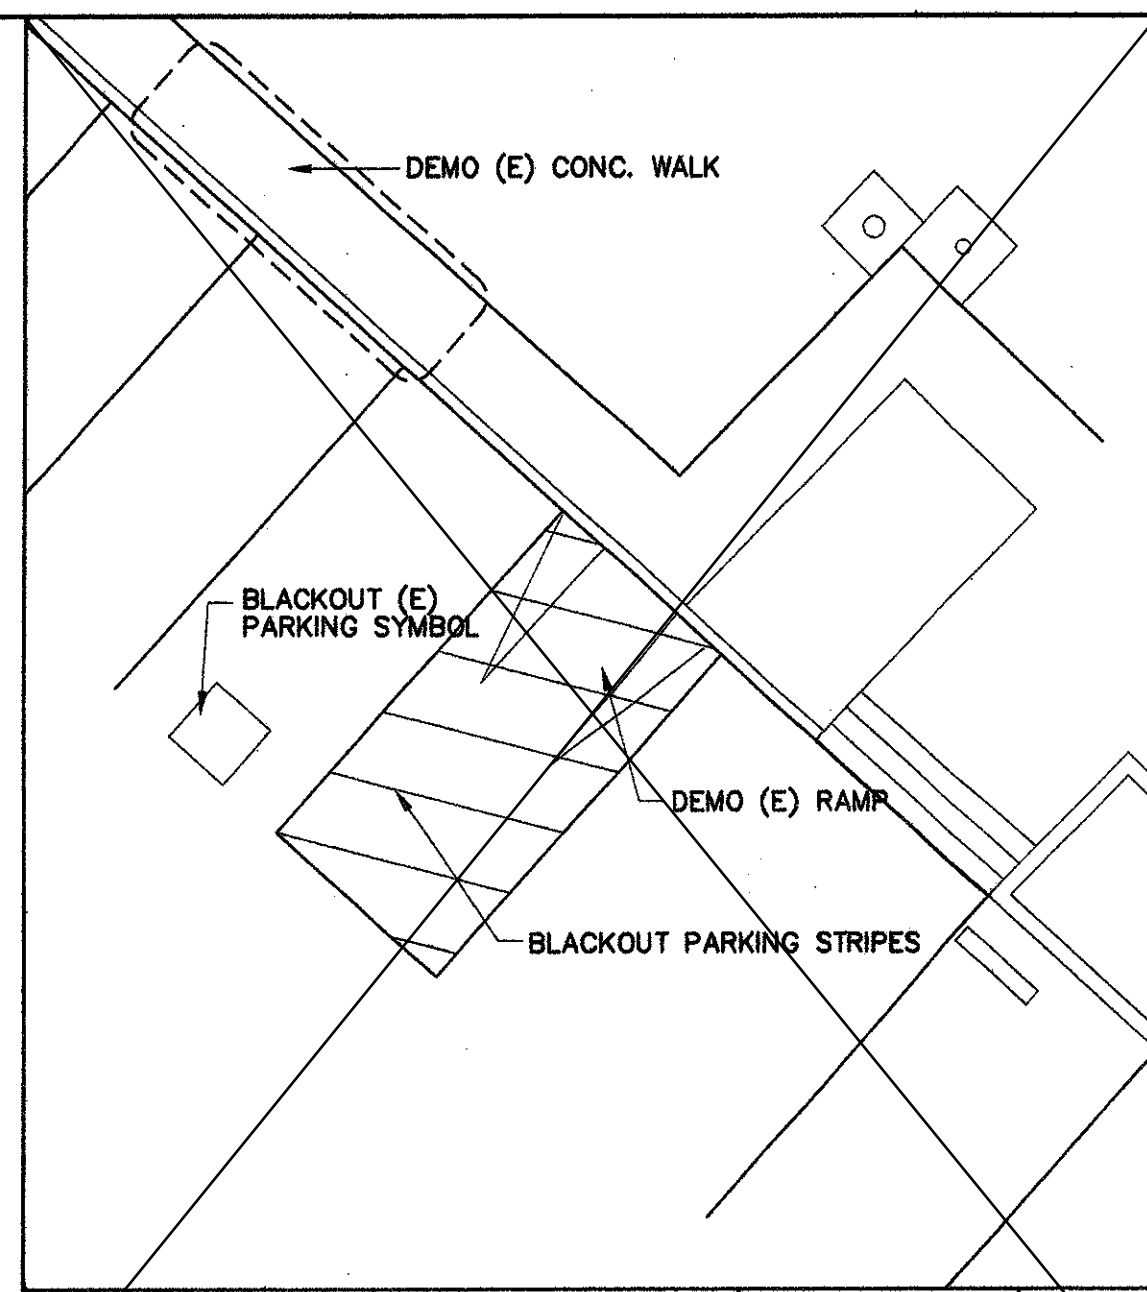


DEMO PARKING PLAN 1/8"=1'-0" 2

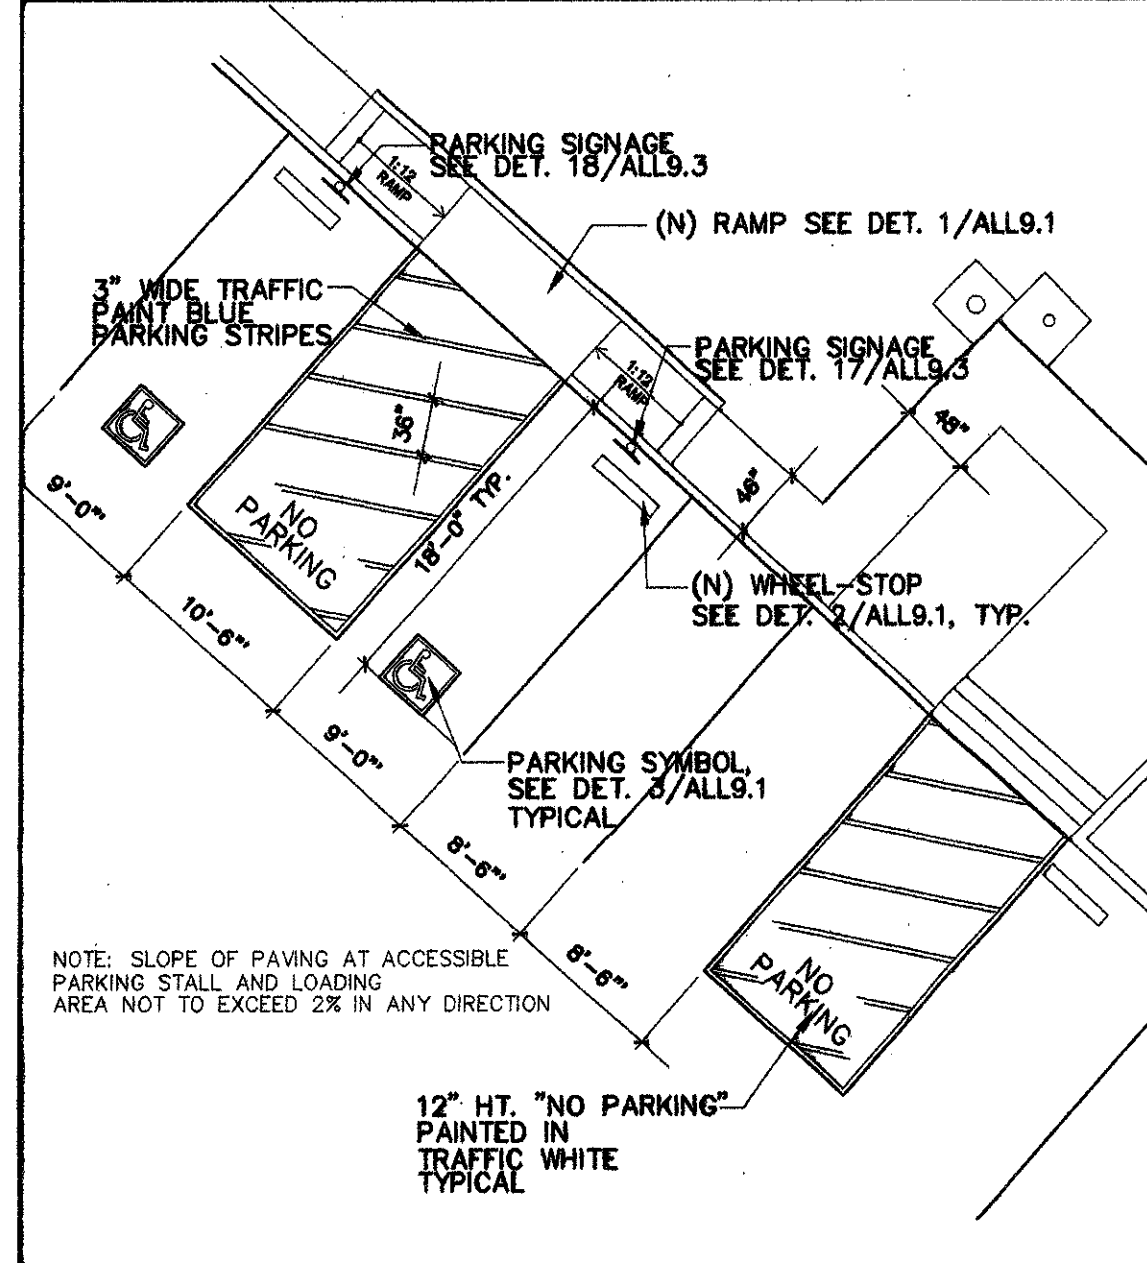

NEW PARKING PLAN 1"=10'-0" 3

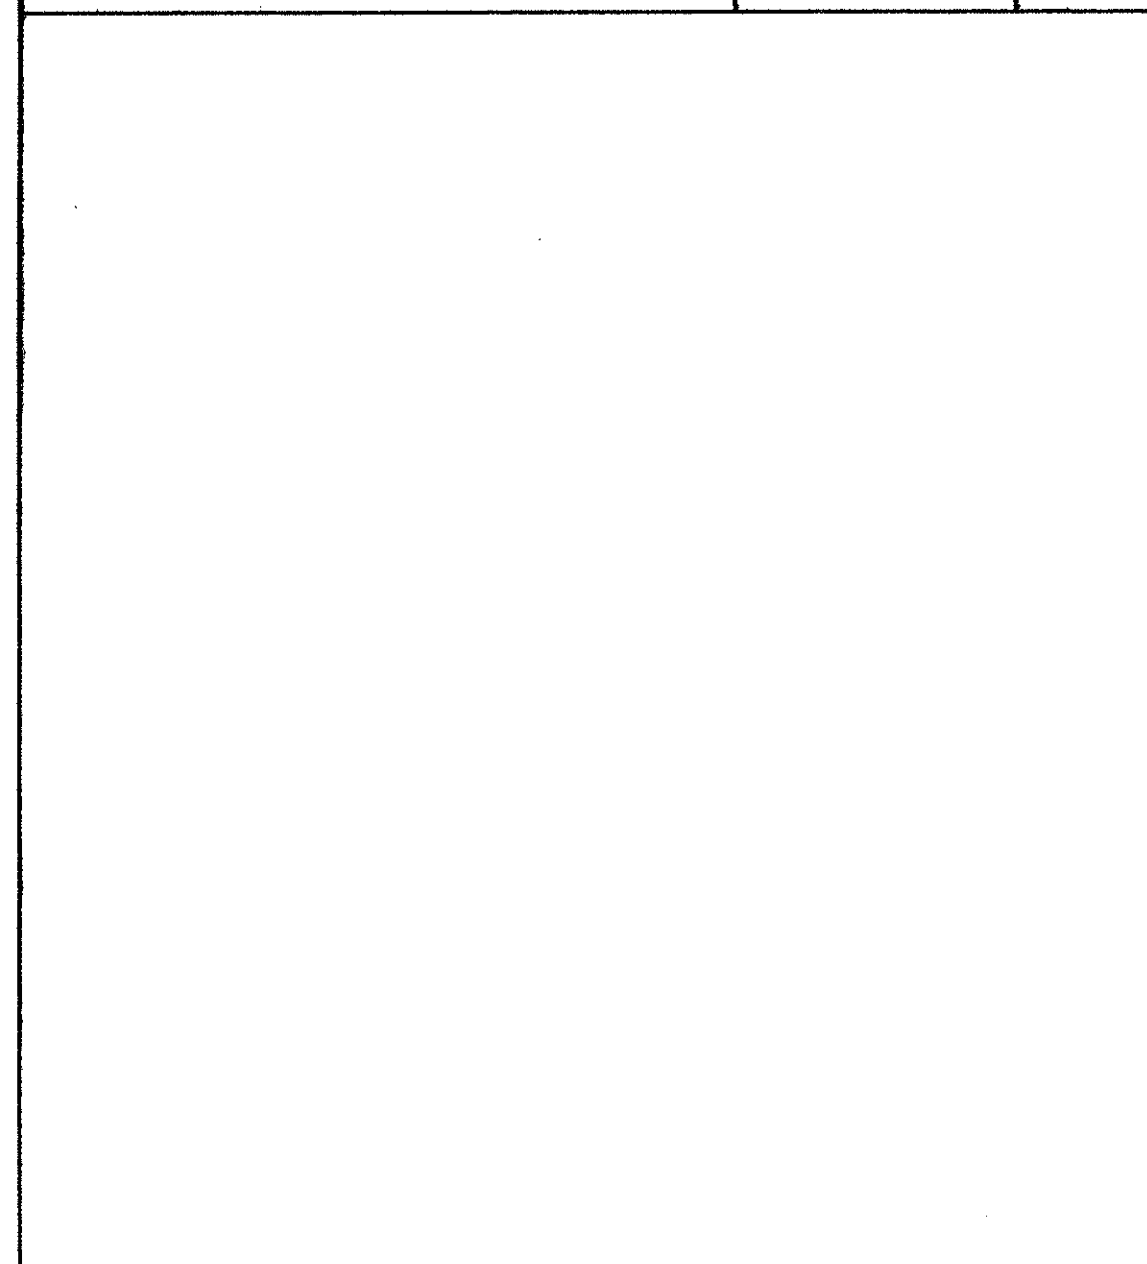

NEW PARKING PLAN 1"=10'-0" 5

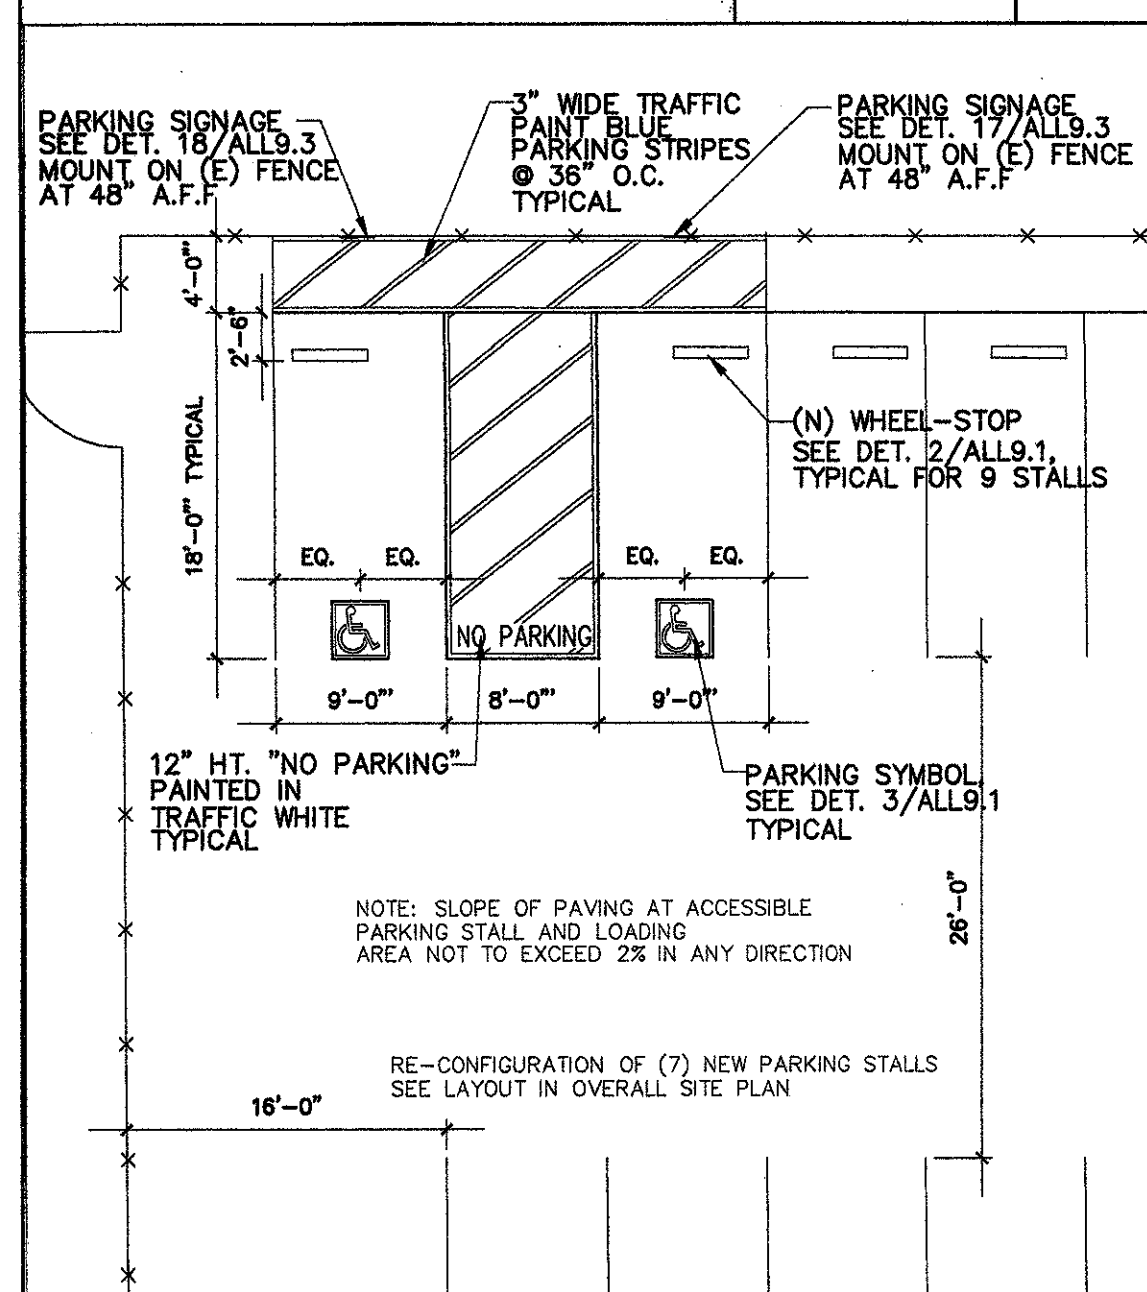

DEMO PARKING PLAN 1"=10'-0" 1

1. DEMO / INSTALL APPROX. 55,000' SQFT OF AC PAVING (N) 4" AC PAVING OVER 4" BASE COMPACTED TO 90%. (N) WHEEL STOPS AND (N) PARKING STALL STRIPING TO MATCH (E) PARKING STALL LAYOUT OR AS DIRECTED BY DISTRICT / CM (N) SEAL COAT THROUGHOUT.
 2. DEMO APPROX. 13,000' SQFT OF (E) AC PAVING AND PREP FOR NEW FINISH PER 7/.
 3. INSTALL (N) MARATHON SOD OVER (N) TOP SOIL. (N) SPRINKLER HEADS SHALL COVER ALL NEWLY INSTALLED SOD. TAP (N) LATERAL IRRIGATION LINES TO (E) IRRIGATION LINES.
 4. INSTALL (N) 4" CONCRETE OVER 4" OF 90% COMPACTED BASE. REVIEW SPECIFICATIONS FOR PROPOSED CONCRETE REINFORCEMENT.
- NEW 16"X16" SD GRATE SHALL TIE INTO (E) SD SYSTEM OR TO THE NEAREST SD GULLY

REFERENCE NOTES

- RESTROOMS
- SCOPE OF WORK
- EXISTING FIRE HYDRANT

LEGEND

PATH OF TRAVEL

| PARKING LOT 1 | STALL TYPE | | | |
|---|------------|------------|---|----|
| | STANDARD | ACCESSIBLE | | |
| TOTAL PARKING SPACES = 27 | | | | |
| ACCESSIBLE PARKING SPACE REQ'D (2001 CBC TABLE 11B-6) = 2 | 25 | 1 | 1 | 27 |

| PARKING LOT 2 | STALL TYPE | | | |
|---|------------|------------|---|----|
| | STANDARD | ACCESSIBLE | | |
| TOTAL PARKING SPACES = 36 | | | | |
| ACCESSIBLE PARKING SPACE REQ'D (2001 CBC TABLE 11B-6) = 2 | 34 | 1 | 1 | 36 |

PARKING TABULATION

BLACK-OUT (E) PARKING STALLS AND PREPARE FOR NEW

PARKING TABULATION



BLACK-OUT (E) PARKING STALLS AND PREPARE FOR NEW

DEMO PARKING PLAN 1"=10'-0" 1


2023 PAVING
LAKELAND ELEMENTARY SCHOOL
 11224 BOMBARDIER AVE
 NORWALK CA, 90650

OVERALL SITE PLAN


DRAWING NUMBER: ALL.1.1

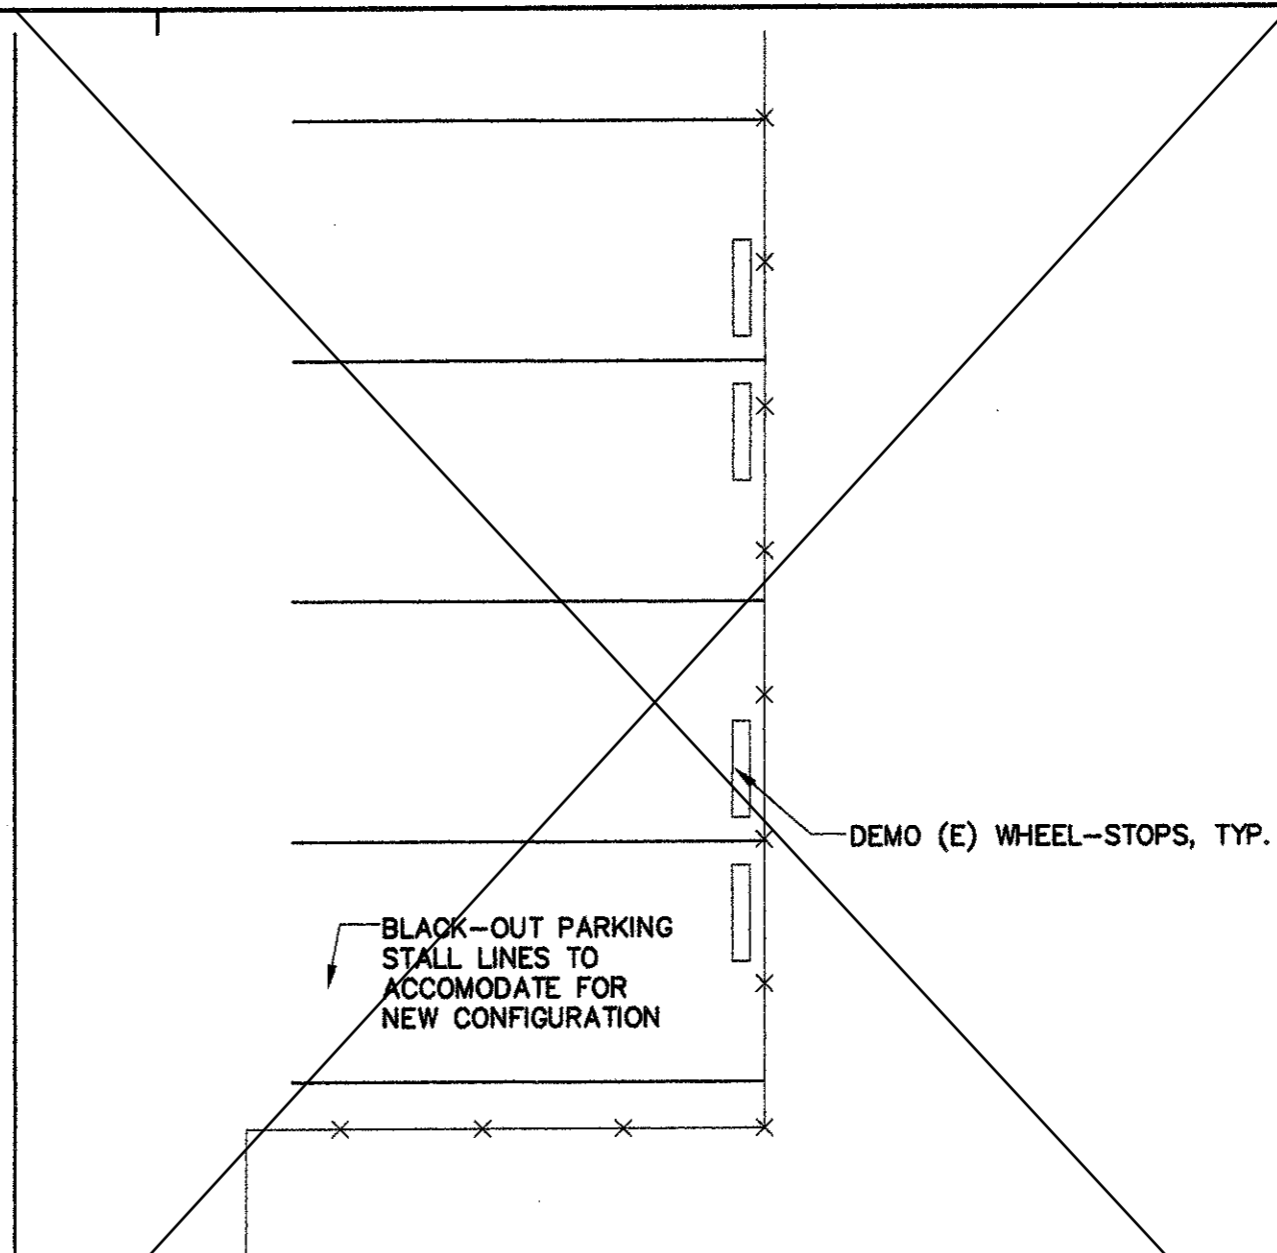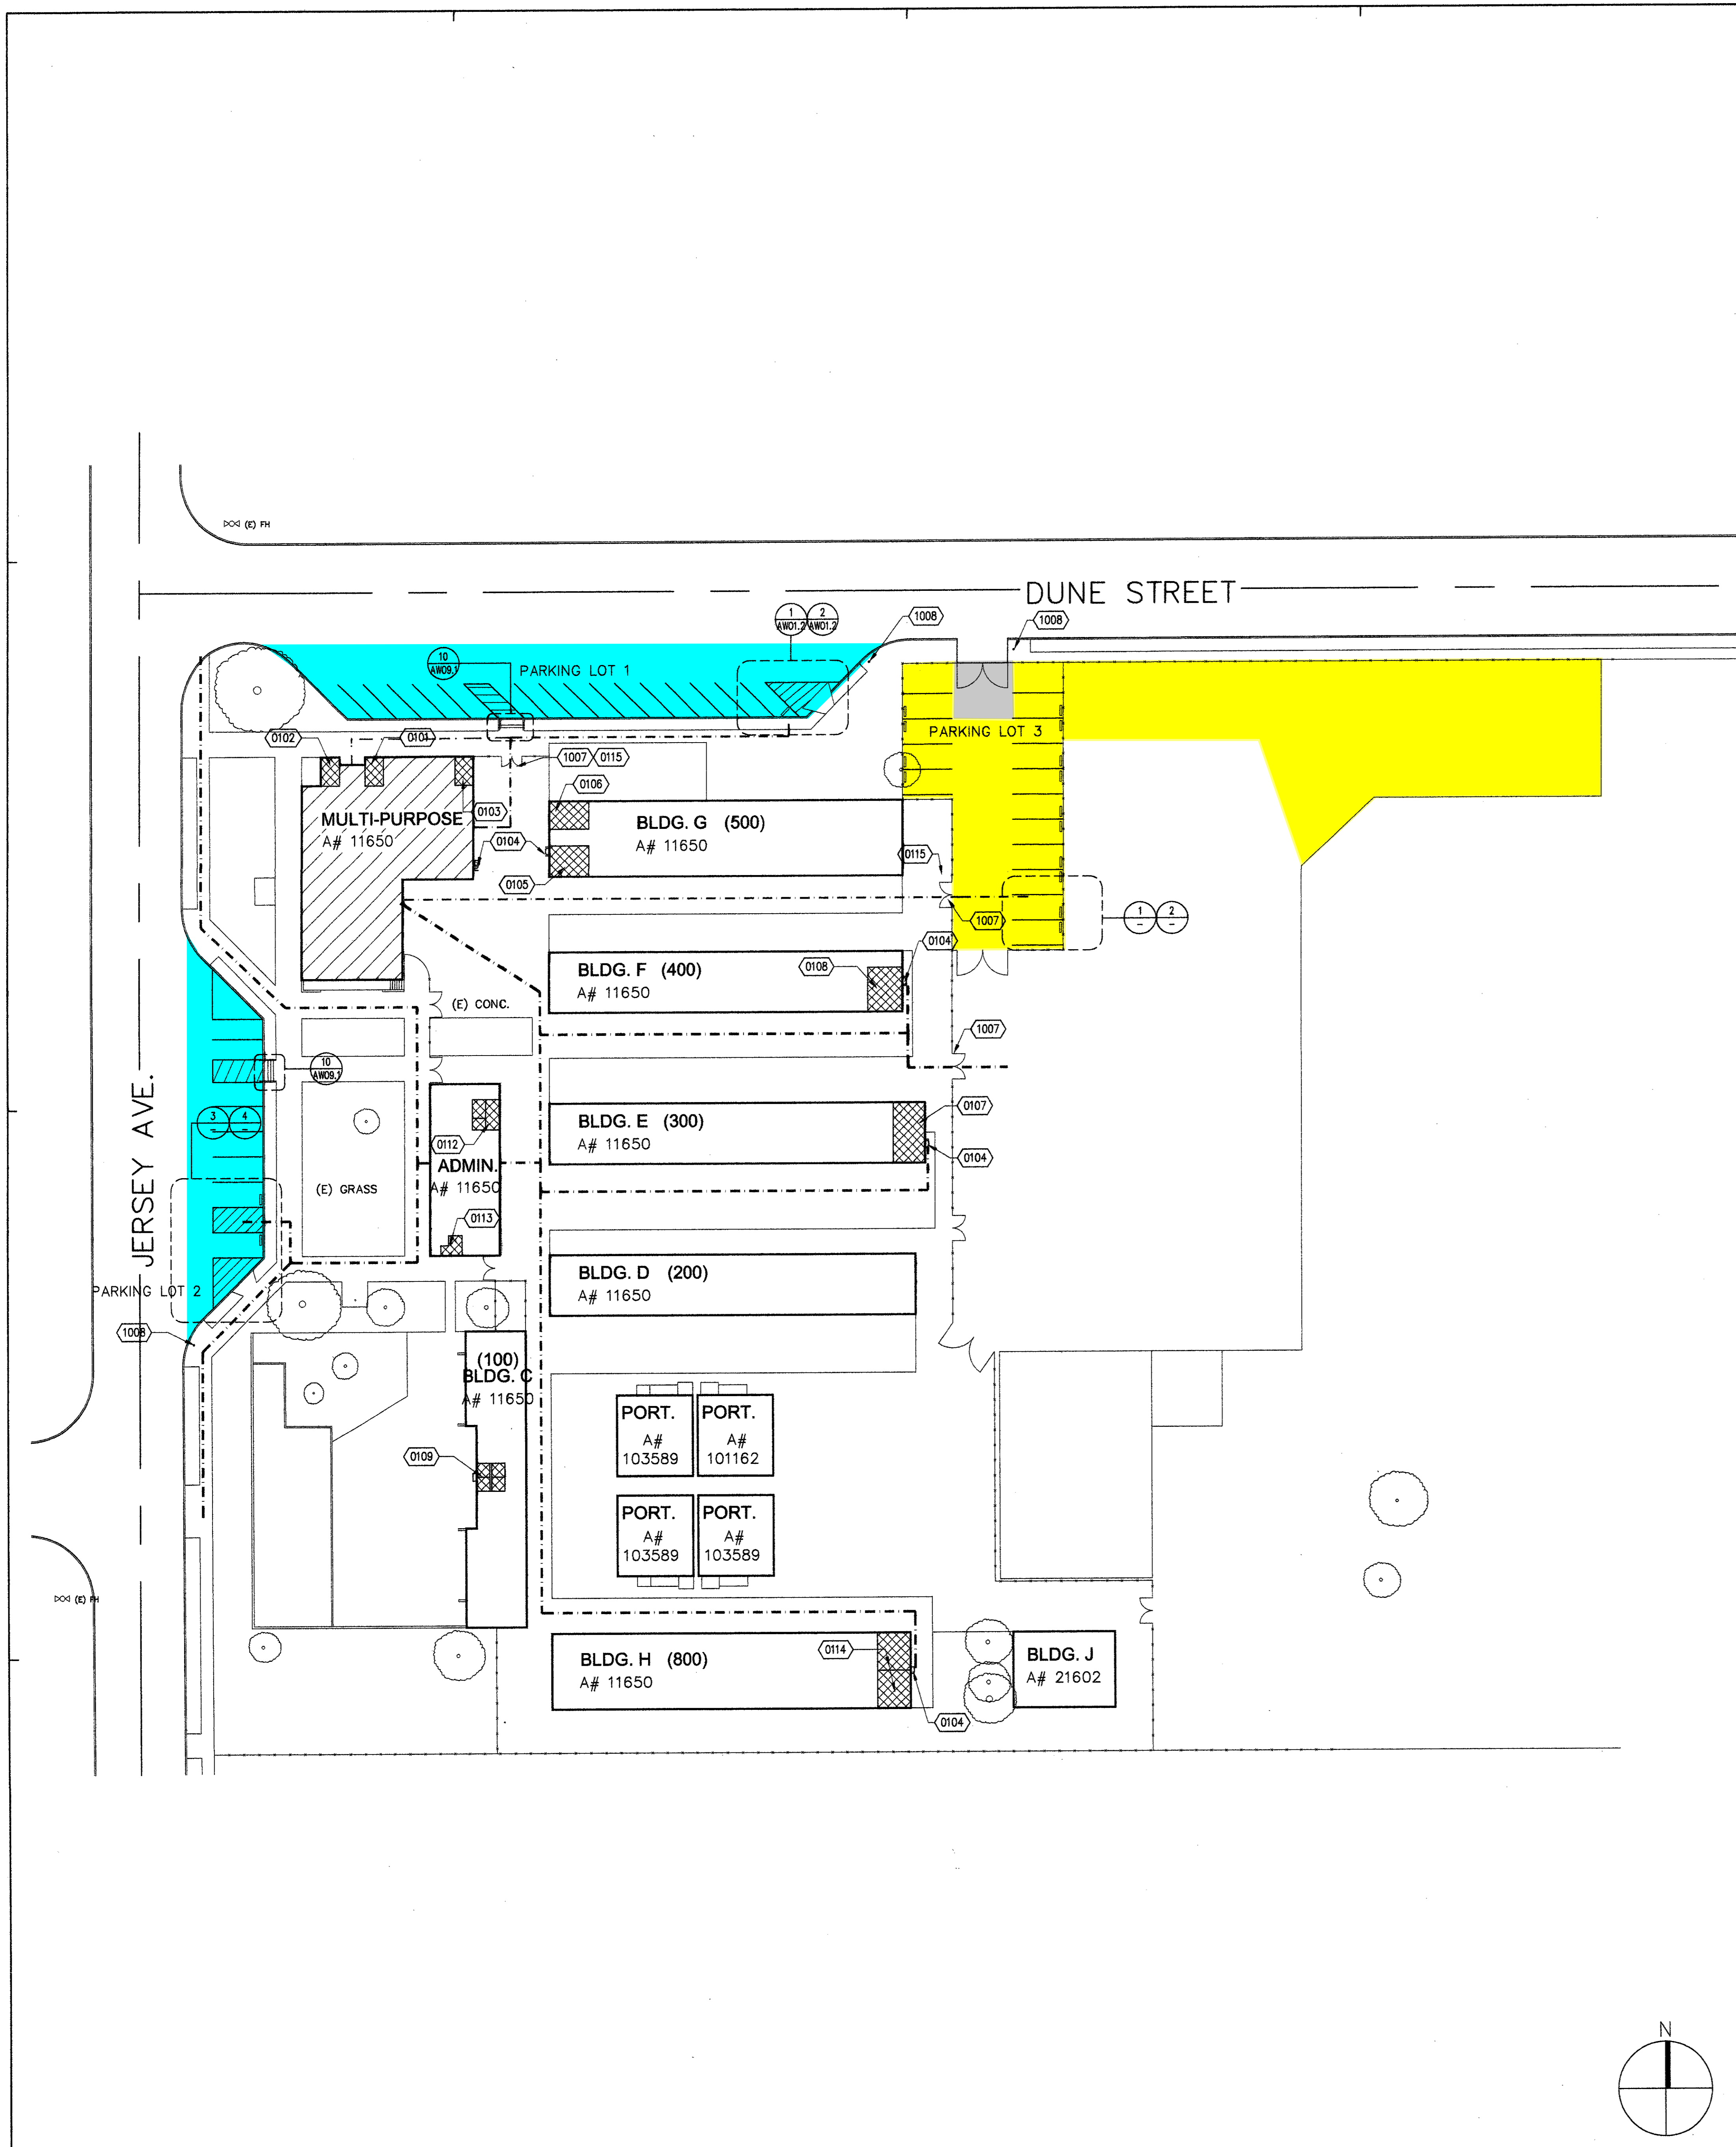


DEMO PARKING PLAN (PARKING LOT 3) 1/8"=1'-0" 1

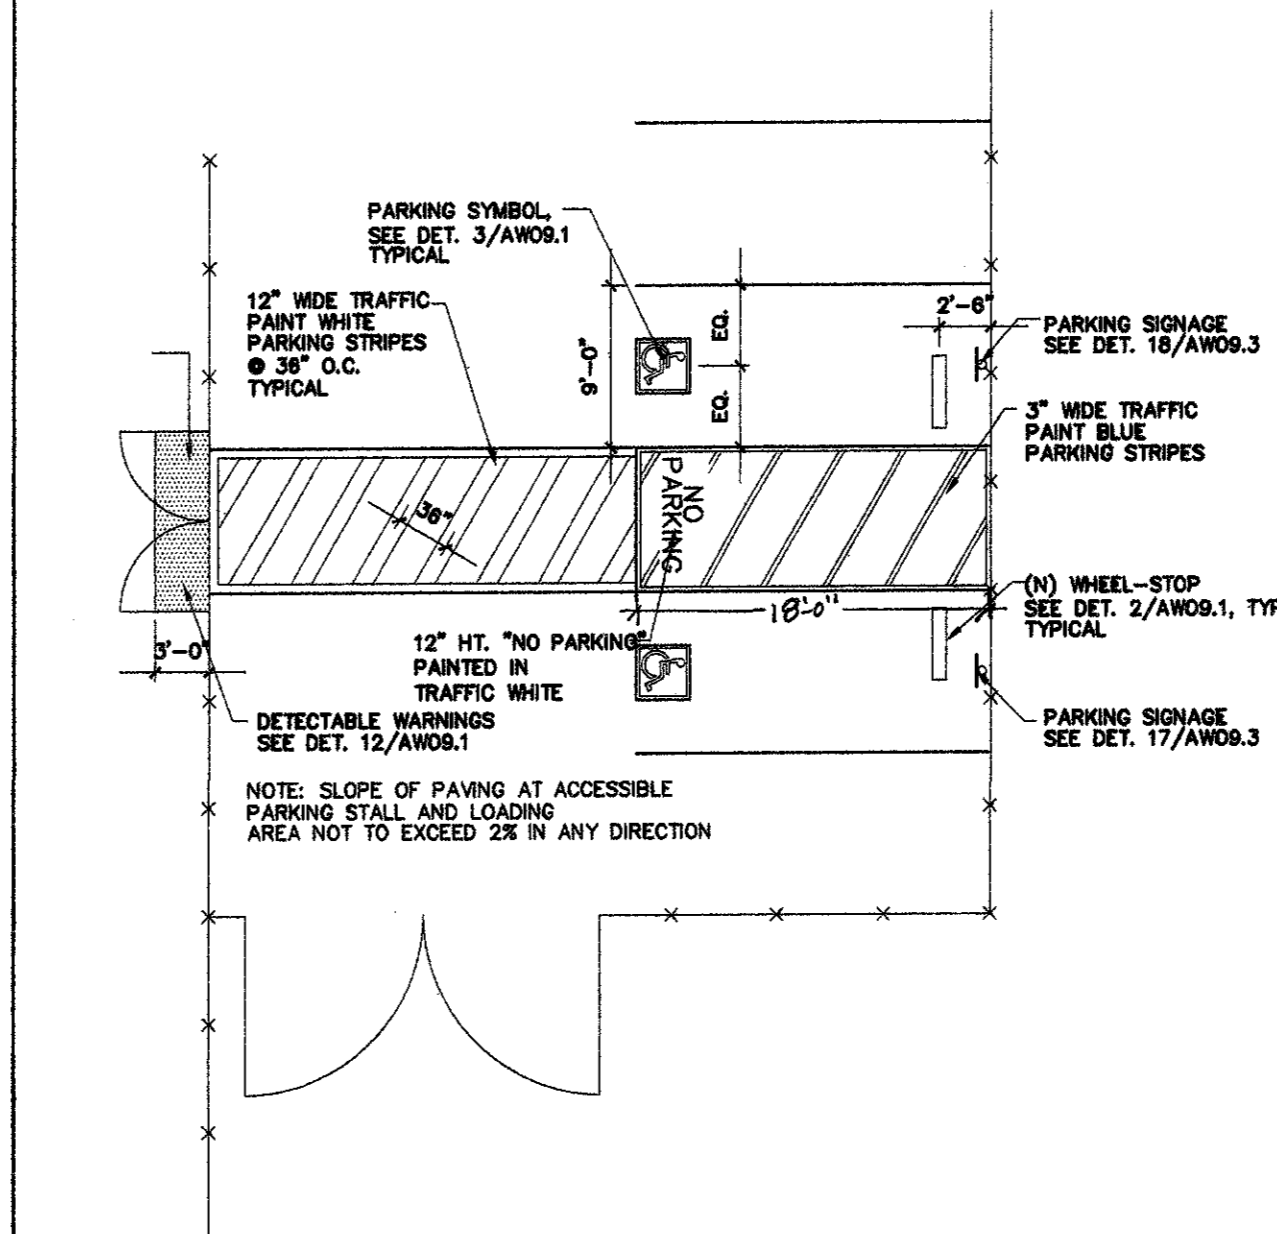

NEW PARKING PLAN (PARKING LOT 3) 3/32"=1'-0" 2

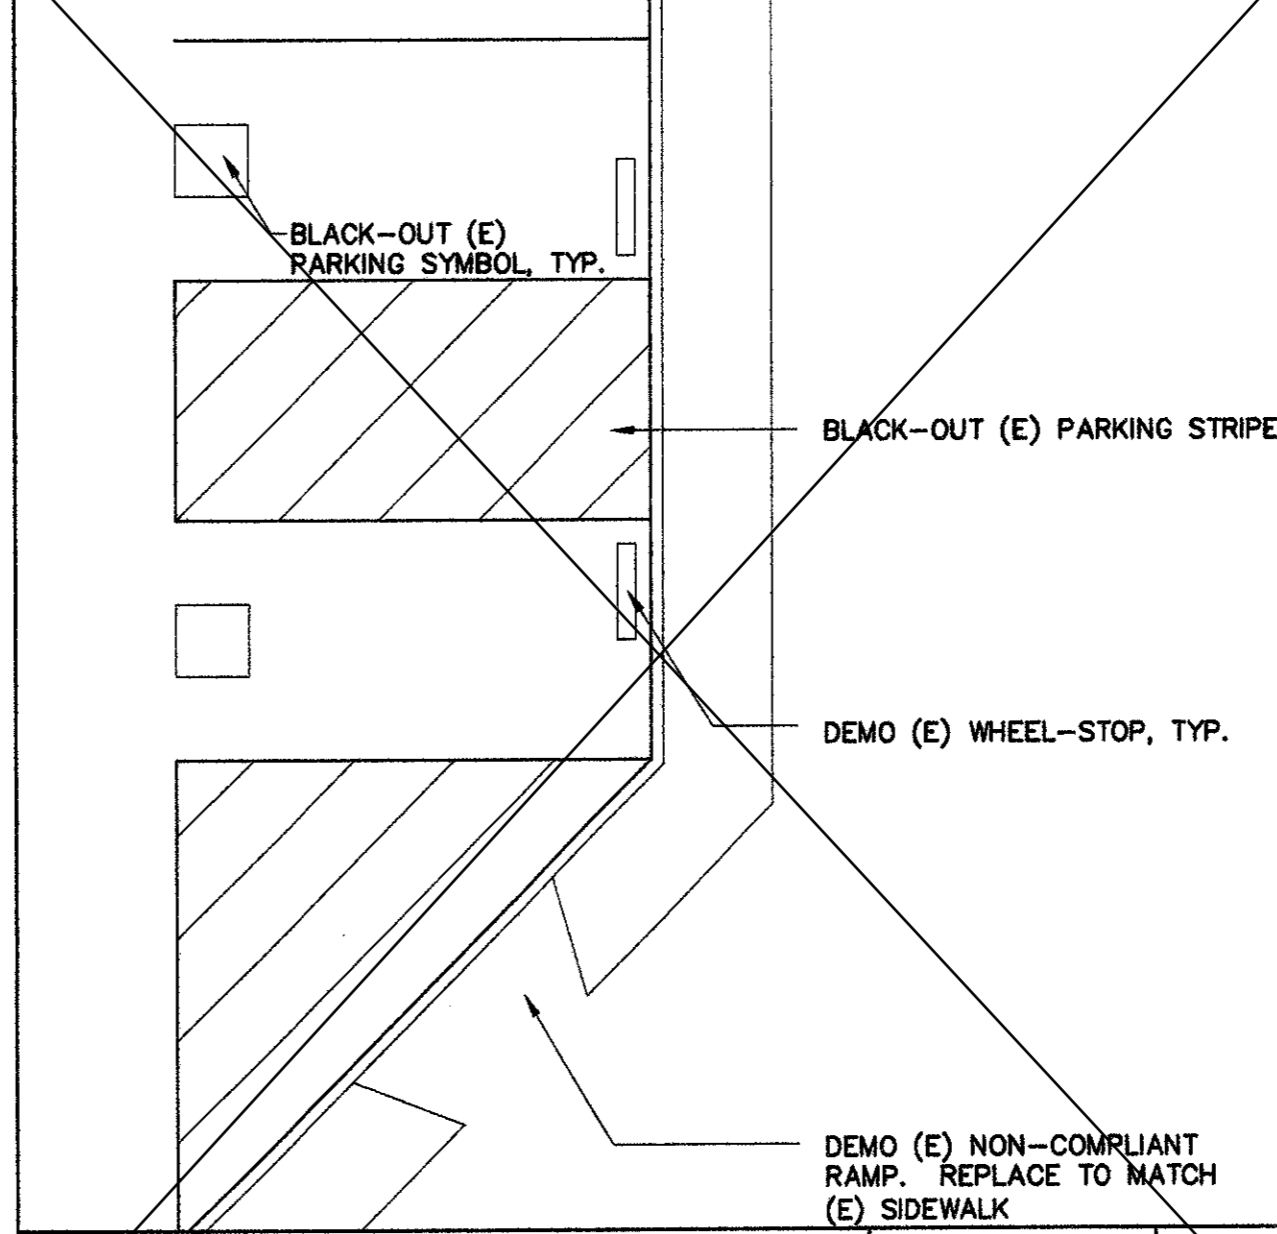

DEMO PARKING PLAN 1/8"=1'-0" 3

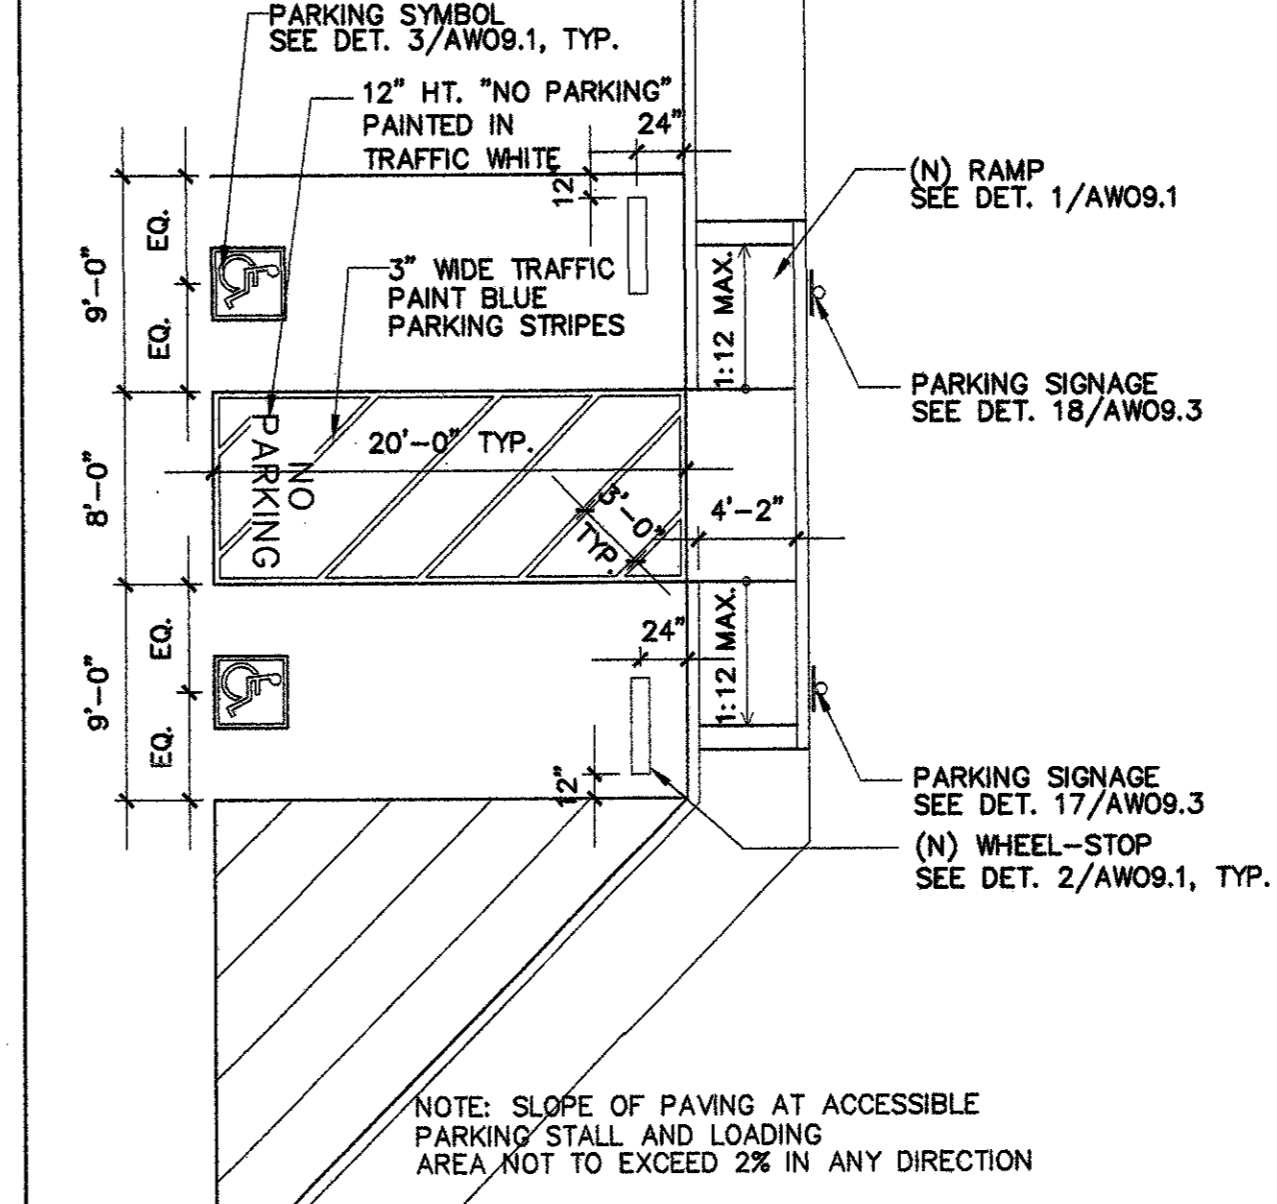

NEW PARKING PLAN 1/8"=1'-0" 4

1. DEMO / INSTALL APPROX: 11,000 SQFT OF AC PAVING (N) 4" AC PAVING OVER 4" BASE COMPACTED TO 90%. (N) WHEEL STOPS AND (N) PARKING STALL STRIPING TO MATCH (E) PARKING STALL LAYOUT OR AS DIRECTED BY DISTRICT / CM. (N) SEAL COAT THROUGHOUT.
2. INSTALL APPROX: 600 SQFT (N) 4" CONCRETE OVER 4" OF 90% COMPACTED BASE. REVIEW SPECIFICATIONS FOR PROPOSED CONCRETE REINFORCEMENT.
3. (N) CRACK FILL / SEAL COAT APPROX: 17,000 SQFT. (N) WHEEL STOPS AND (N) PARKING STALL STRIPING TO MATCH (E) PARKING STALL LAYOUT OR AS DIRECTED BY DISTRICT / CM.

REFERENCE NOTES

- RESTROOMS
- SCOPE OF WORK
- EXISTING FIRE HYDRANT

LEGEND

PATH OF TRAVEL

| PARKING LOT 1 TOTAL PARKING SPACES = 16 | STALL TYPE | | |
|---|------------|------------|-------|
| | STANDARD | ACCESSIBLE | TOTAL |
| ACCESSIBLE PARKING SPACE REQ'D (2001 CBC TABLE 11B-6) = 1 | 14 | 1 | 15 |

| PARKING LOT 2 TOTAL PARKING SPACES = 9 | STALL TYPE | | |
|---|------------|------------|-------|
| | STANDARD | ACCESSIBLE | TOTAL |
| ACCESSIBLE PARKING SPACE REQ'D (2001 CBC TABLE 11B-6) = 1 | 7 | 1 | 8 |

| PARKING LOT 3 TOTAL PARKING SPACES = 15 | STALL TYPE | | |
|---|------------|------------|-------|
| | STANDARD | ACCESSIBLE | TOTAL |
| ACCESSIBLE PARKING SPACE REQ'D (2001 CBC TABLE 11B-6) = 1 | 13 | 1 | 14 |

PARKING TABULATION


2023 PAVING
WILLIAM ORR ELEMENTARY SCHOOL
 12130 JERSEY AVE
 NORWALK CA, 90650

OVERALL SITE PLAN
 DRAWING NUMBER **AWO1.1**




OVERALL SITE PLAN

1" = 40'-0" 5

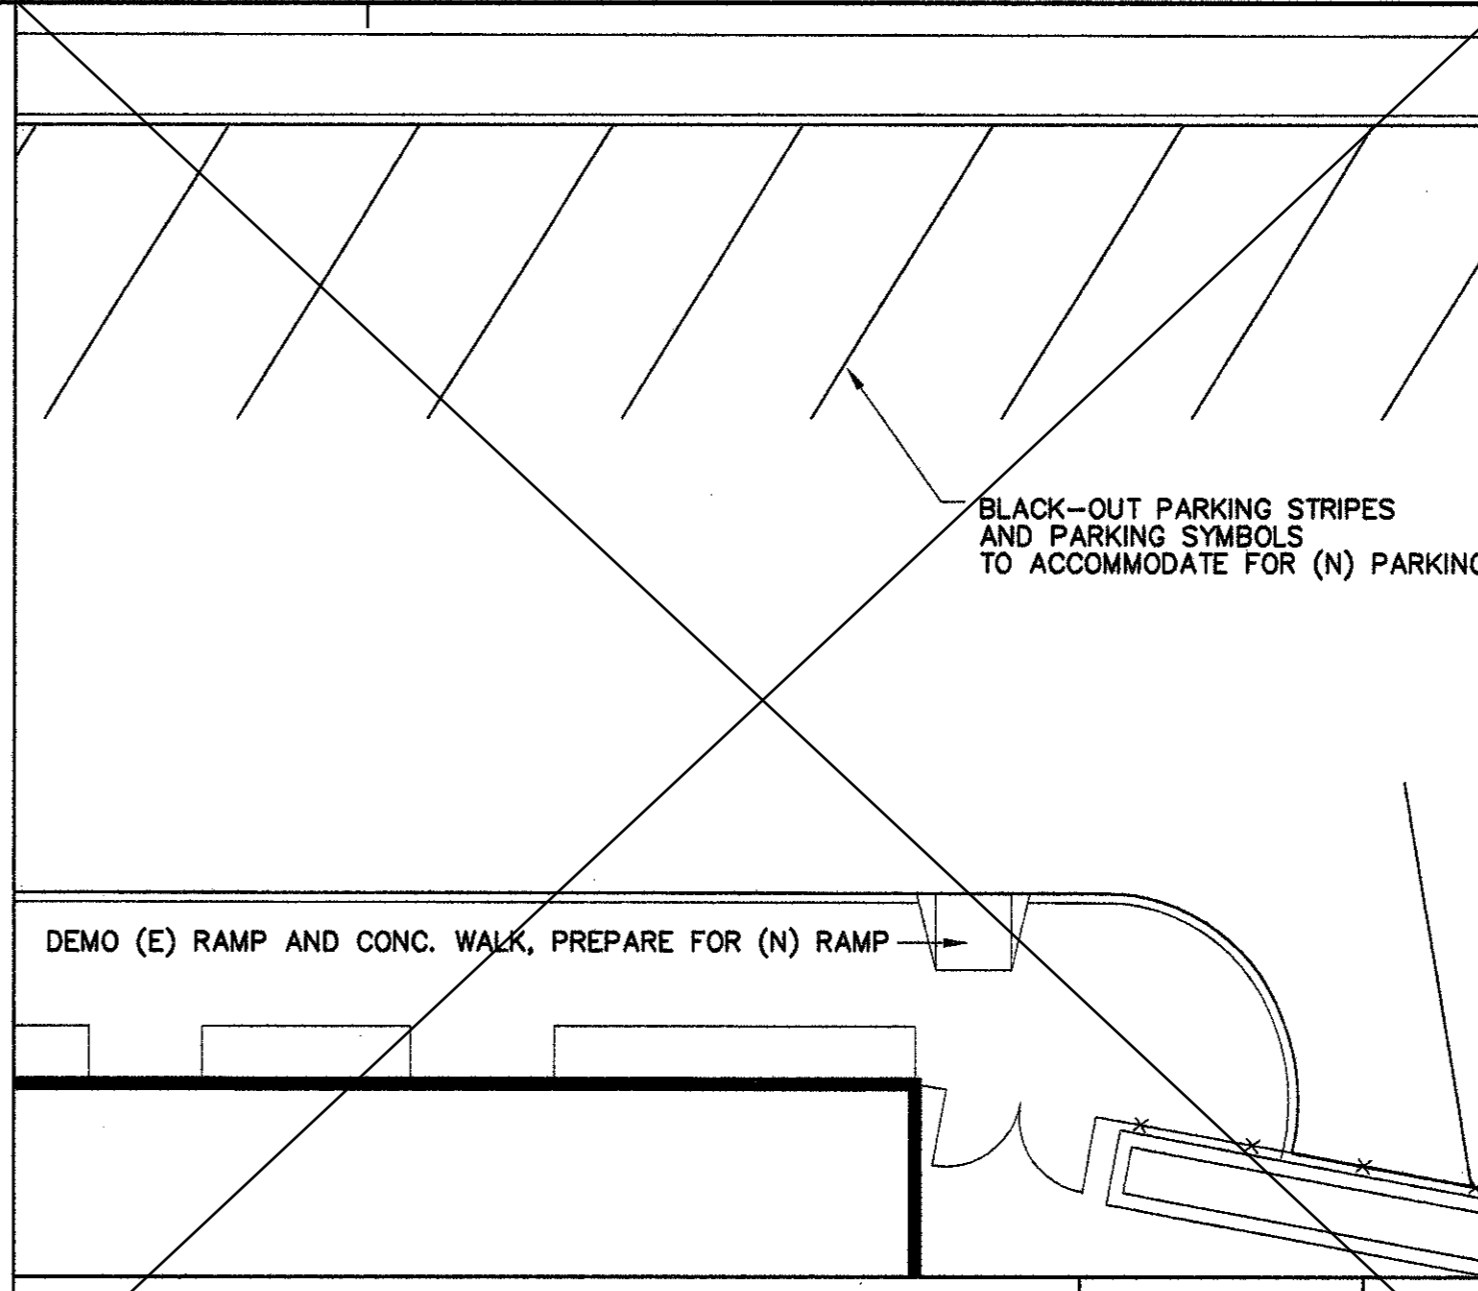

DEMO PARKING PLAN 1"=10'-0" 1

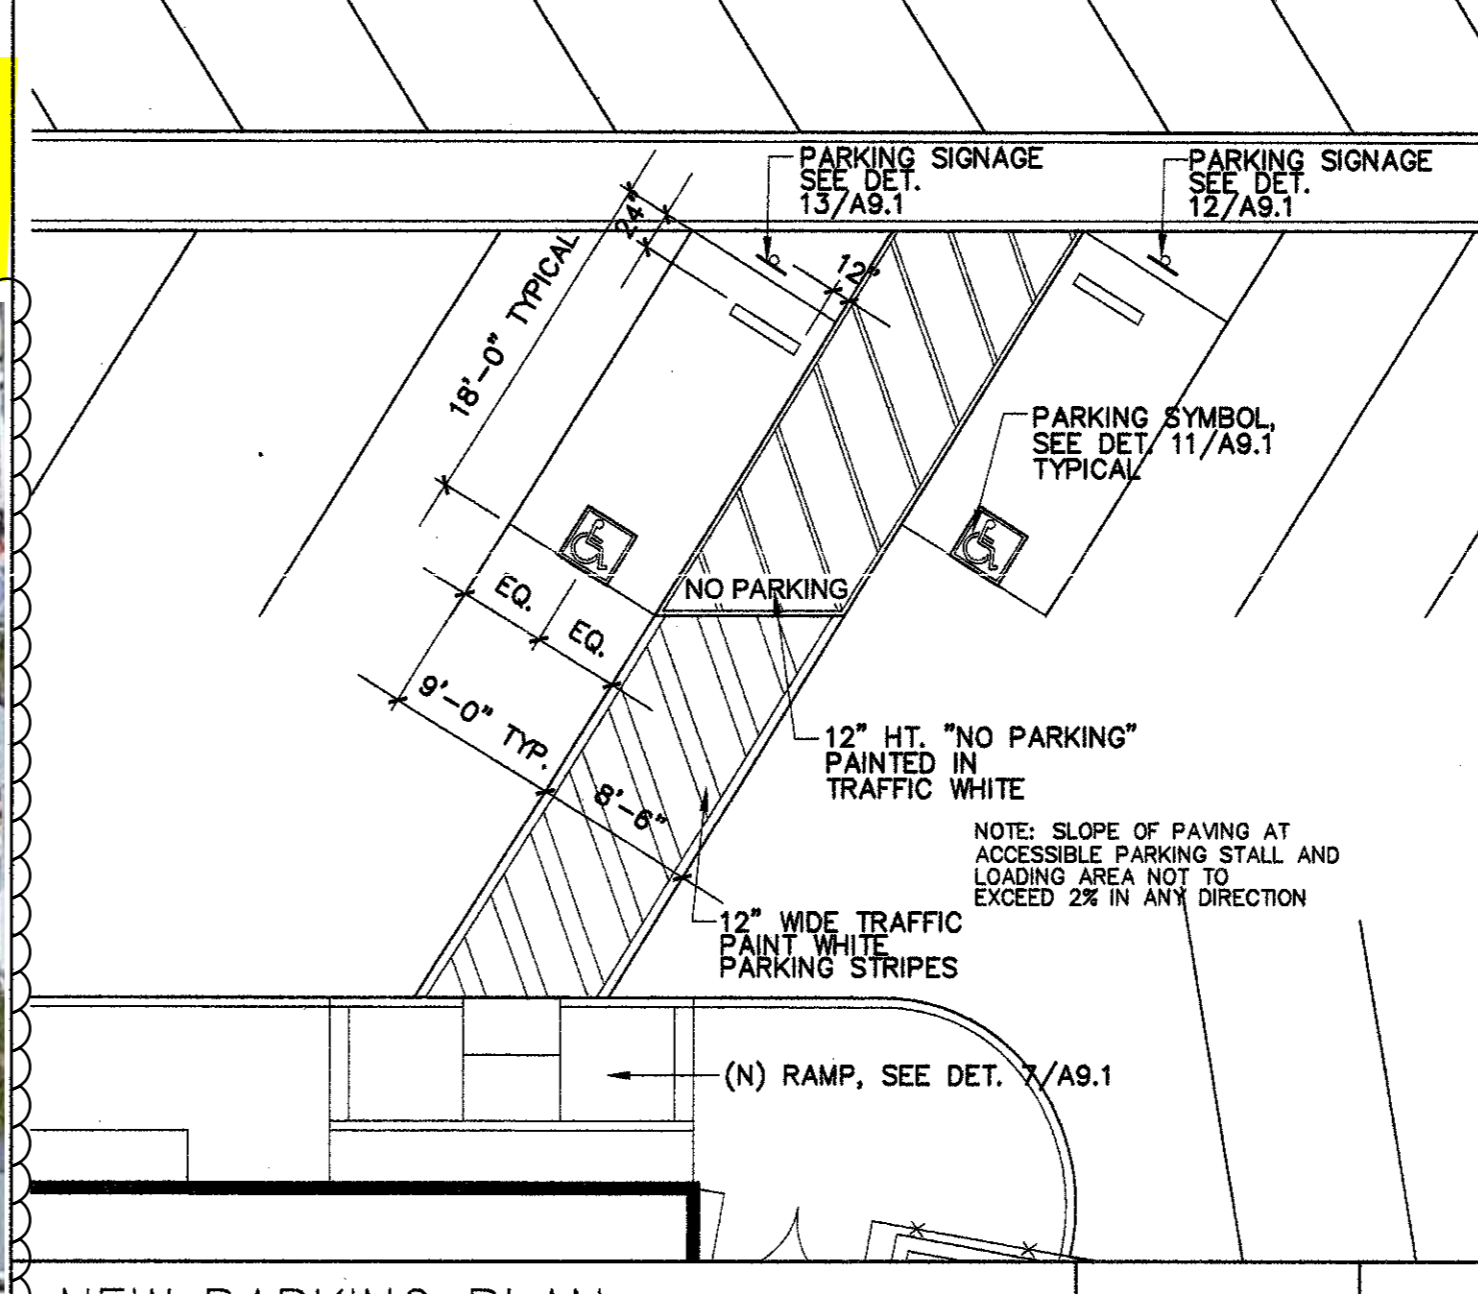

NEW PARKING PLAN 1"=10'-0" 2



1. GRUB / EXPORT / OVER-X 6" AND PREP FOR APPROX: 9,000 SQFT OF NEW 6" AC PAVING OVER 4" BASE COMPACTED TO 90%. (N) RED WOOD HEADERS WHERE AC PAVING MEETING LANDSCAPING. (N) PARKING STALL STRIPING W/ (N) WHEEL STOPS TO ACCOMMODATE 25 (N) PARKING STALLS. (N) SEAL COAT THROUGHOUT.
2. (N) CRACK FILL / SEAL COAT APPROX: 160,000 SQFT. (N) WHEEL STOPS AND (N) PARKING STALL STRIPING TO MATCH (E) PARKING STALL LAYOUT OR AS DIRECTED BY DISTRICT / CM.
3. APPROX: 400' LNFT OF (N) CHAIN LINK FENCE W/ CONCRETE FOOTINGS AND ALL NECESSARY HARDWARE TO MATCH EXISTING MESH DIAMETER AND FENCING HEIGHT

REFERENCE NOTES

- RESTROOMS
- SCOPE OF WORK
- EXISTING FIRE HYDRANT


LEGEND




PATH OF TRAVEL

| | | | | |
|---|------------|------------|-----|-------|
| TOTAL PARKING SPACES = 39 | STALL TYPE | | | |
| ACCESSIBLE PARKING SPACE REQ'D (2001 CBC TABLE 11B-6) = 2 | STANDARD | ACCESSIBLE | | |
| | 37 | STANDARD | VAN | TOTAL |
| | | 1 | 1 | 39 |

PARKING TABULATION

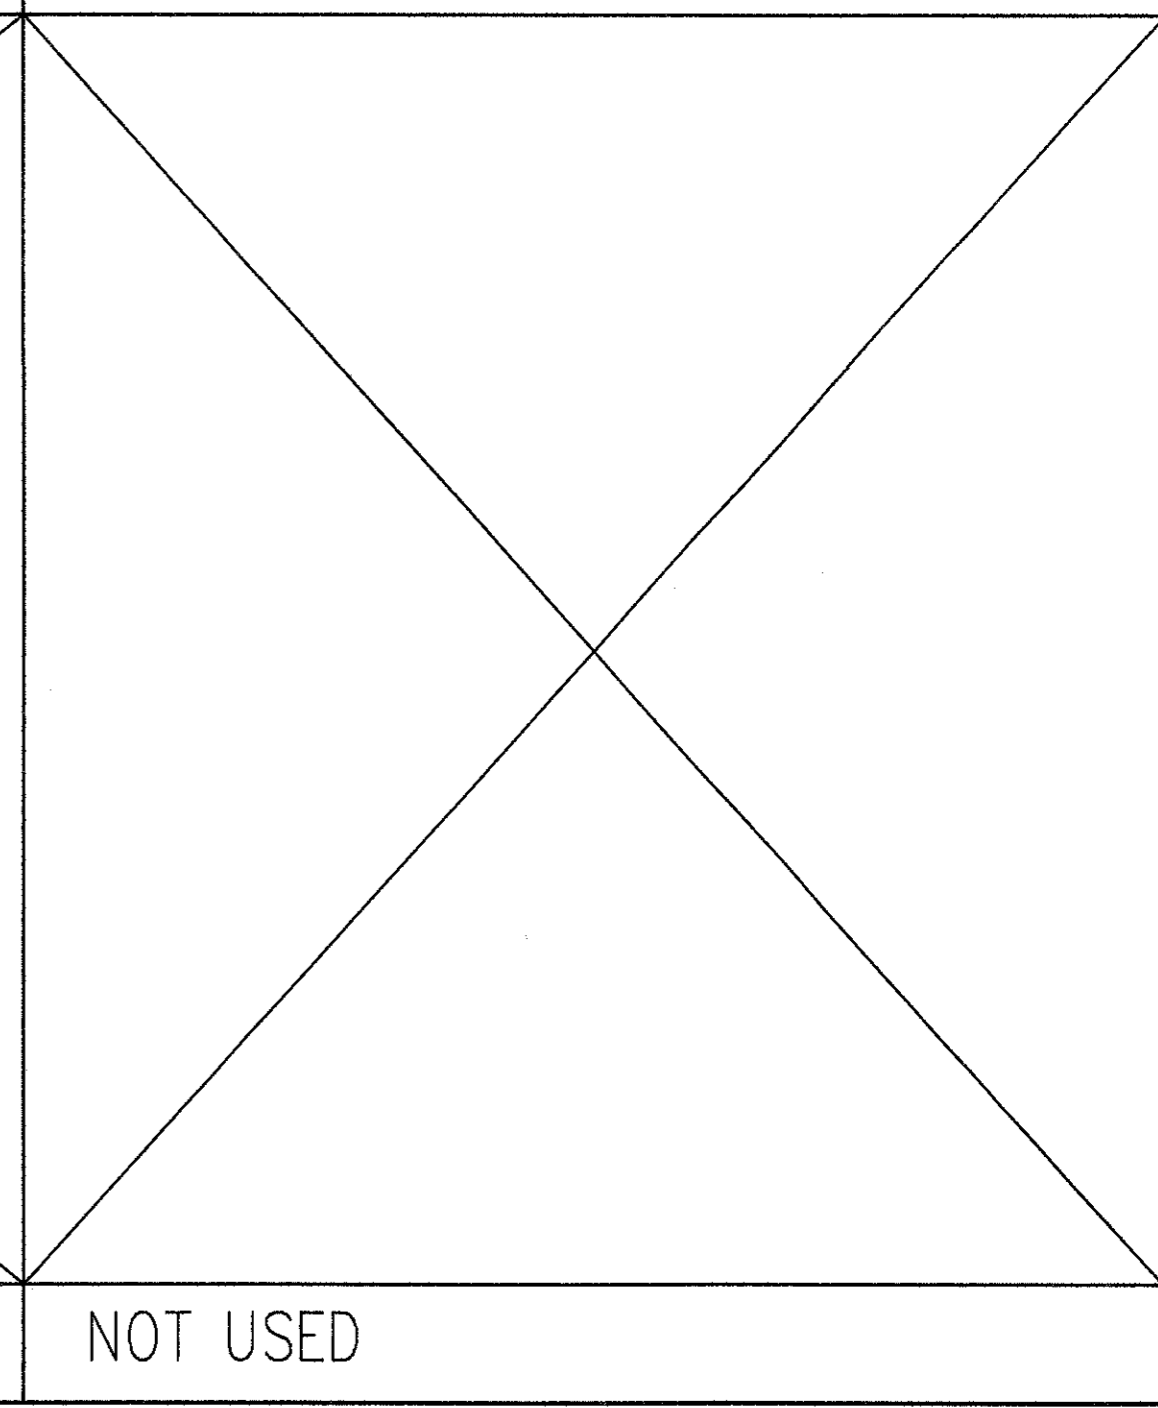

3

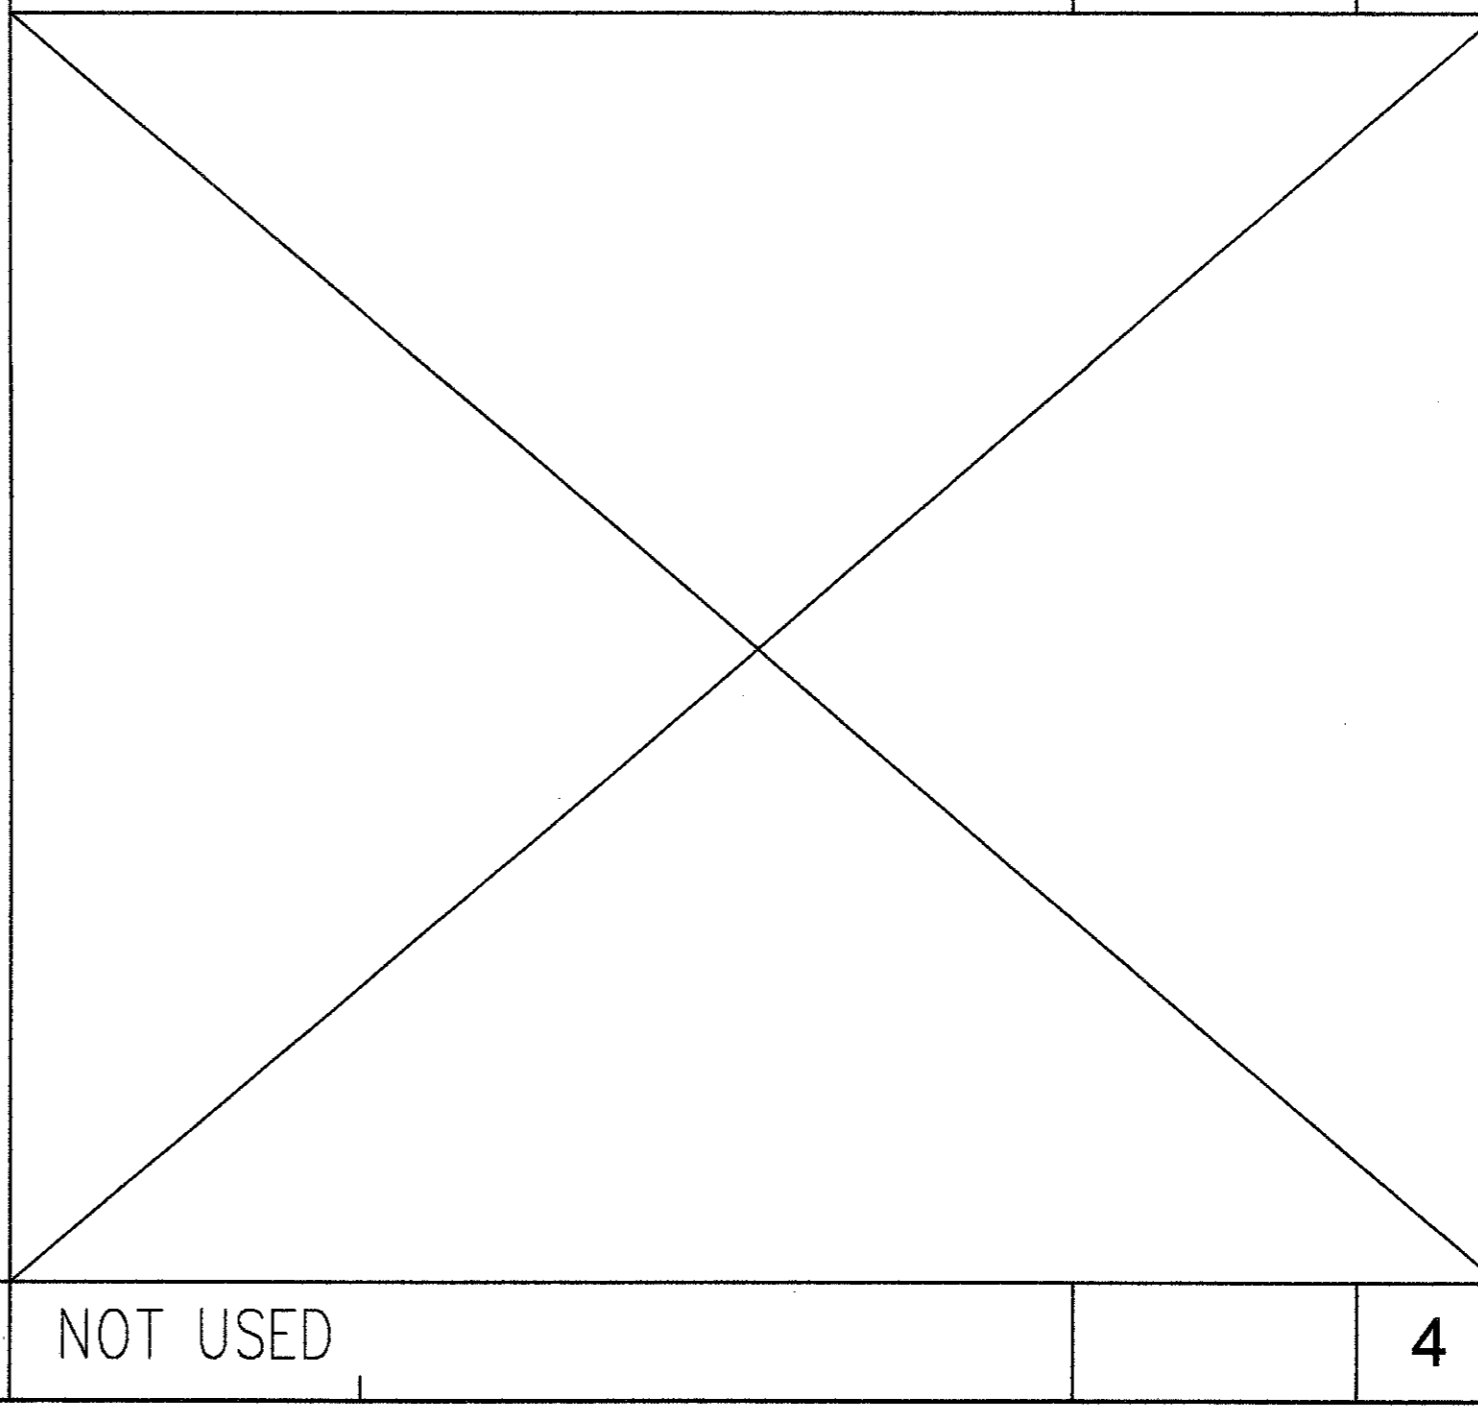

4 NOT USED

5 NOT USED


2023 PAVING

LAKESIDE MIDDLE SCHOOL
11000 KENNEY ST
NORWALK CA, 90650

OVERALL SITE PLAN

DRAWING NUMBER : **ALS1.1**


Health Dept.

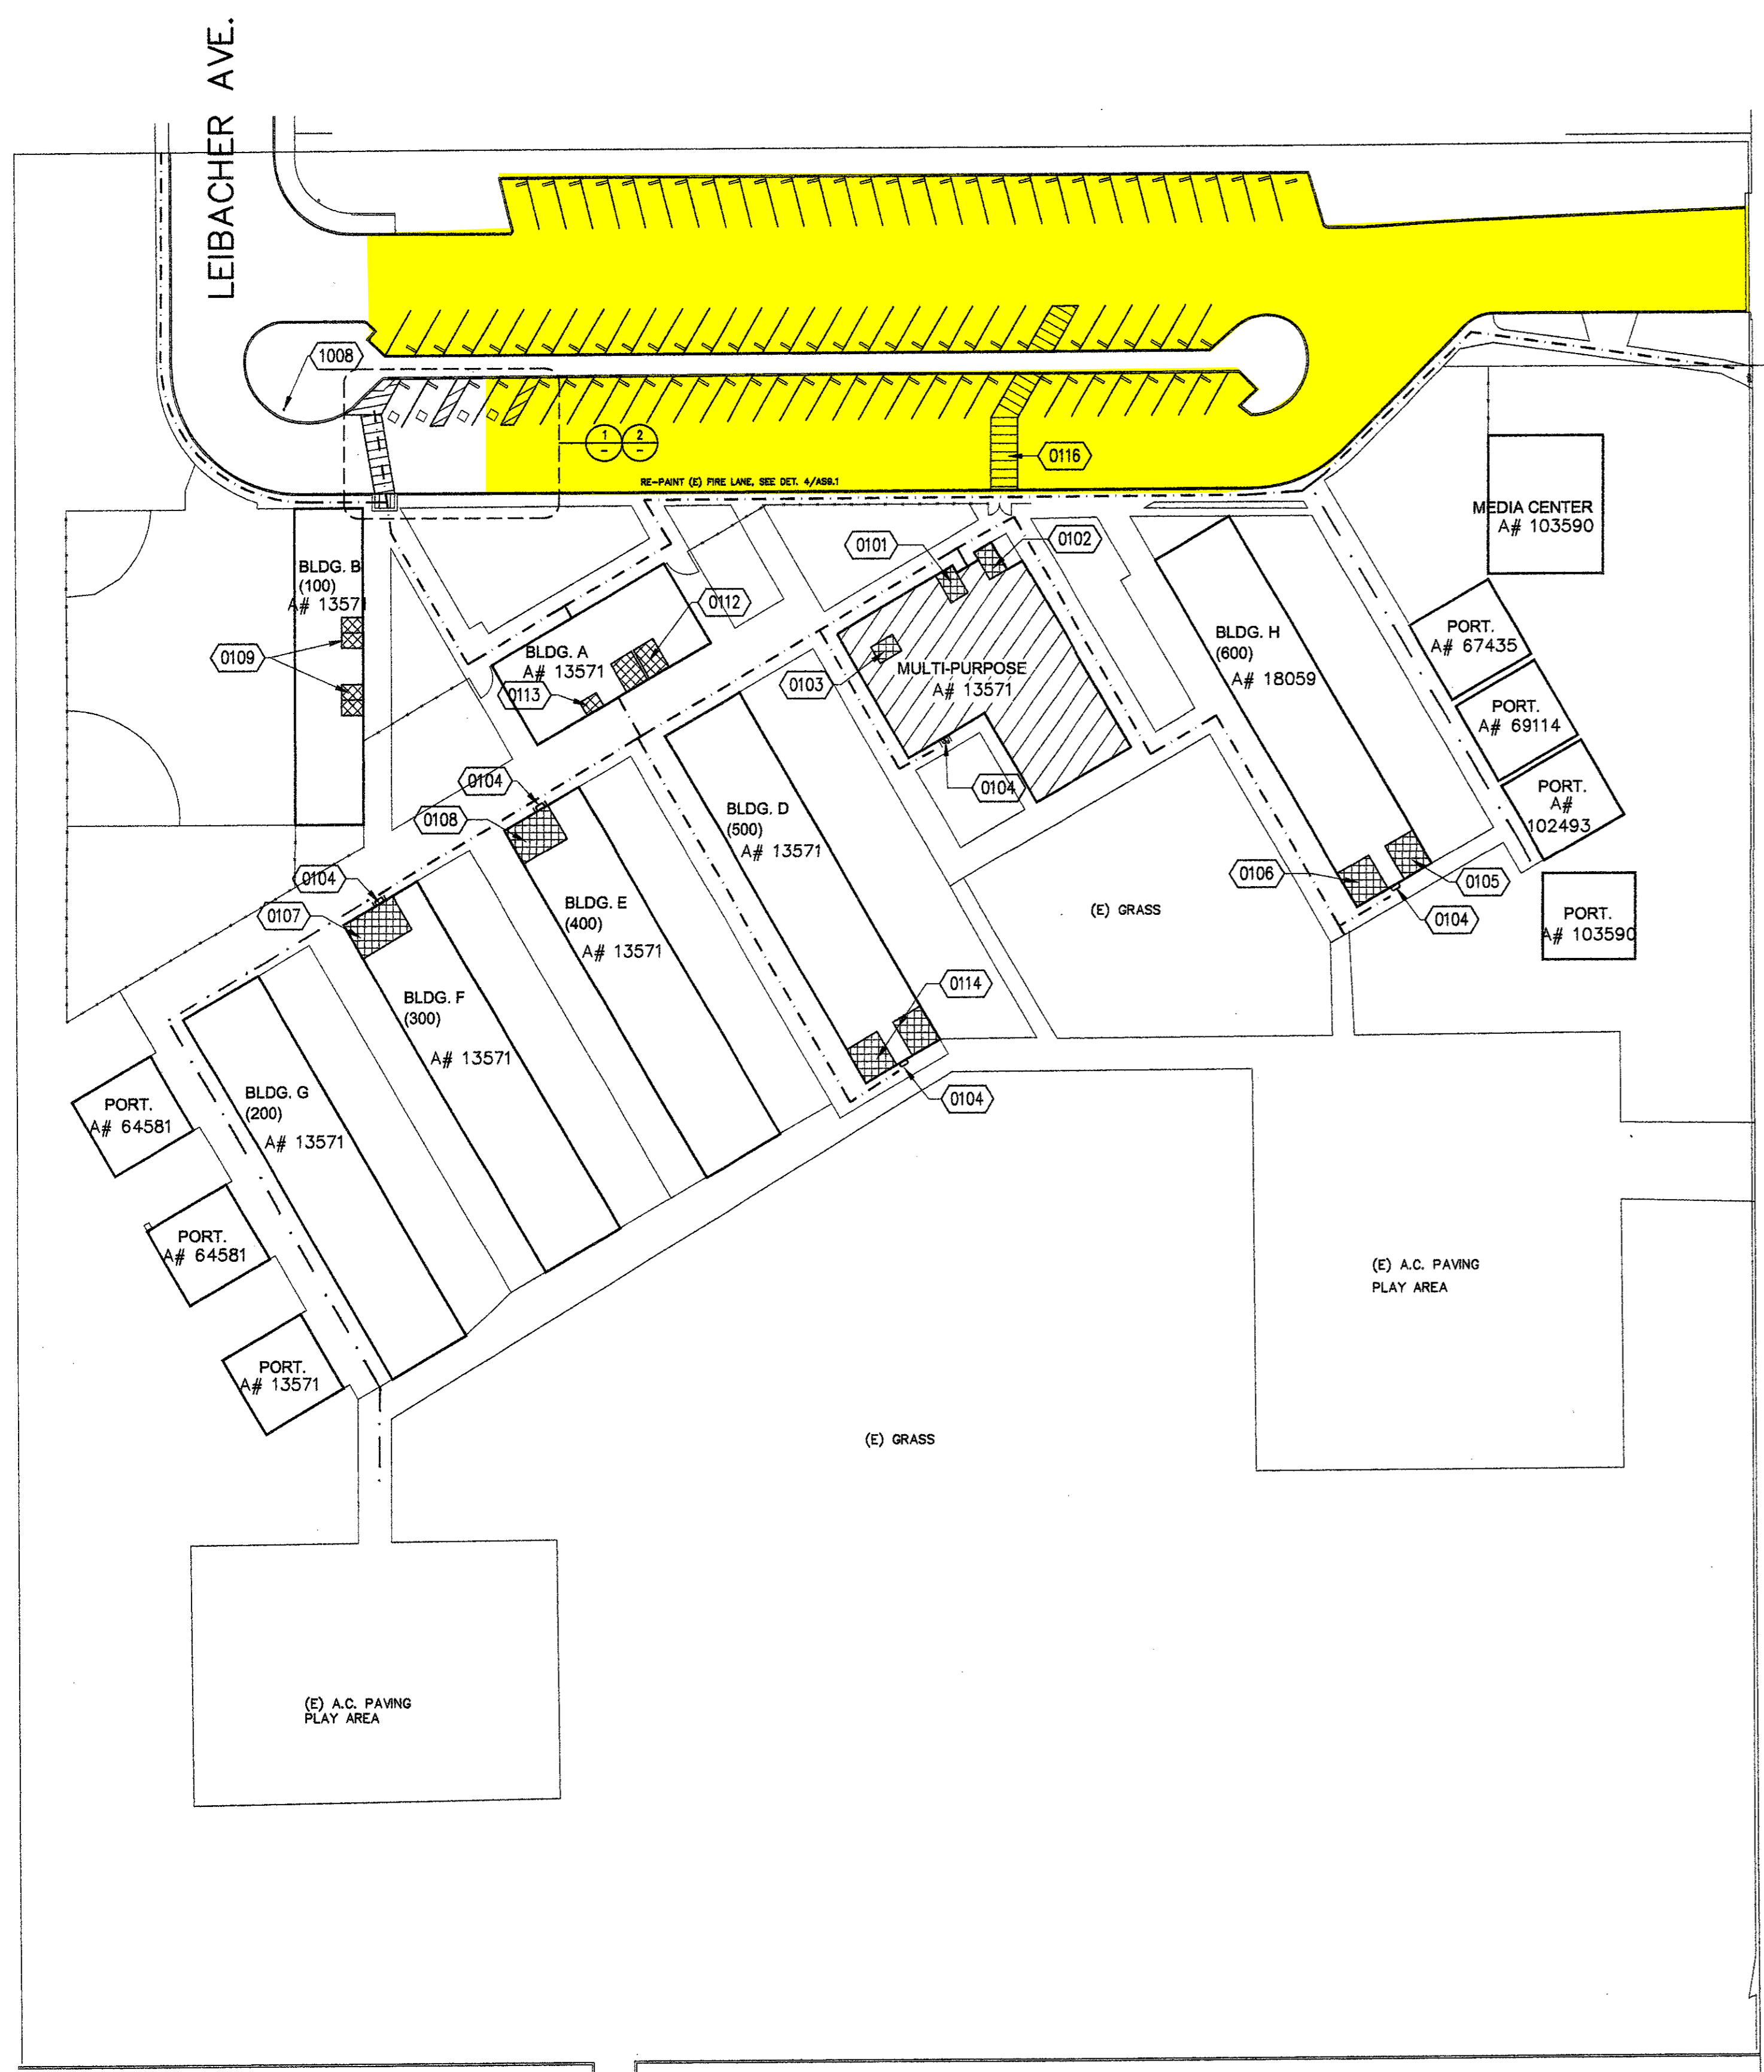

OVERALL SITE PLAN


1" = 40'-0" 3

ENLARGED NEW PARKING PLAN

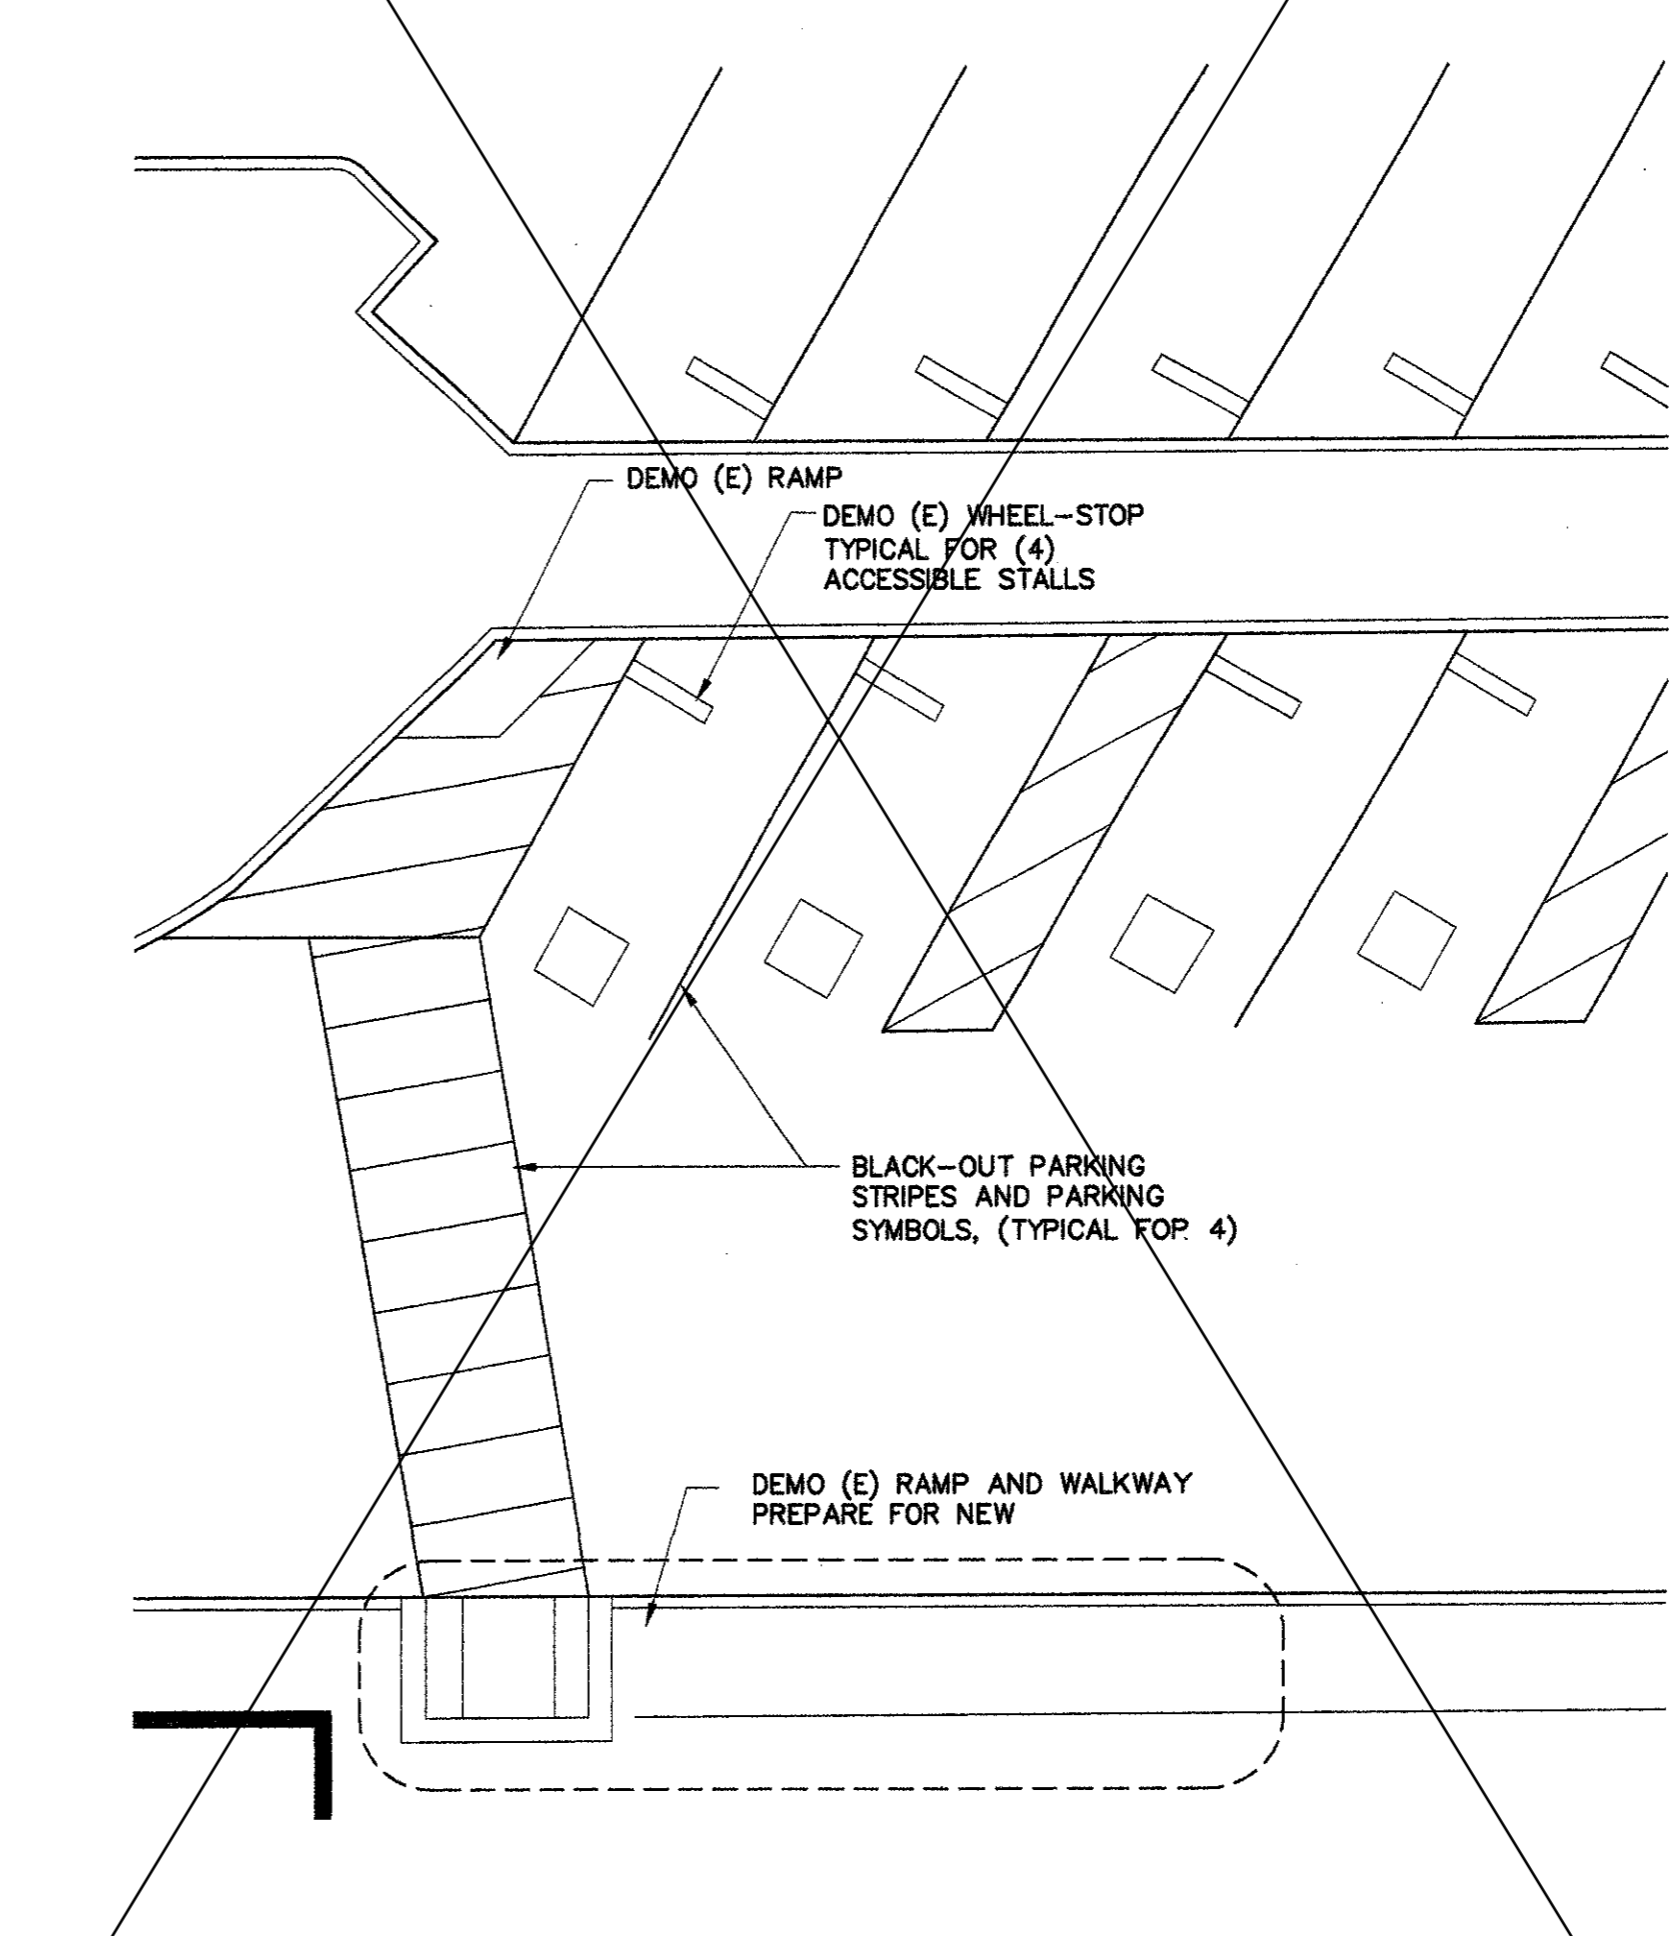

ENLARGED DEMO PARKING PLAN

1/8"=1'-0" 1

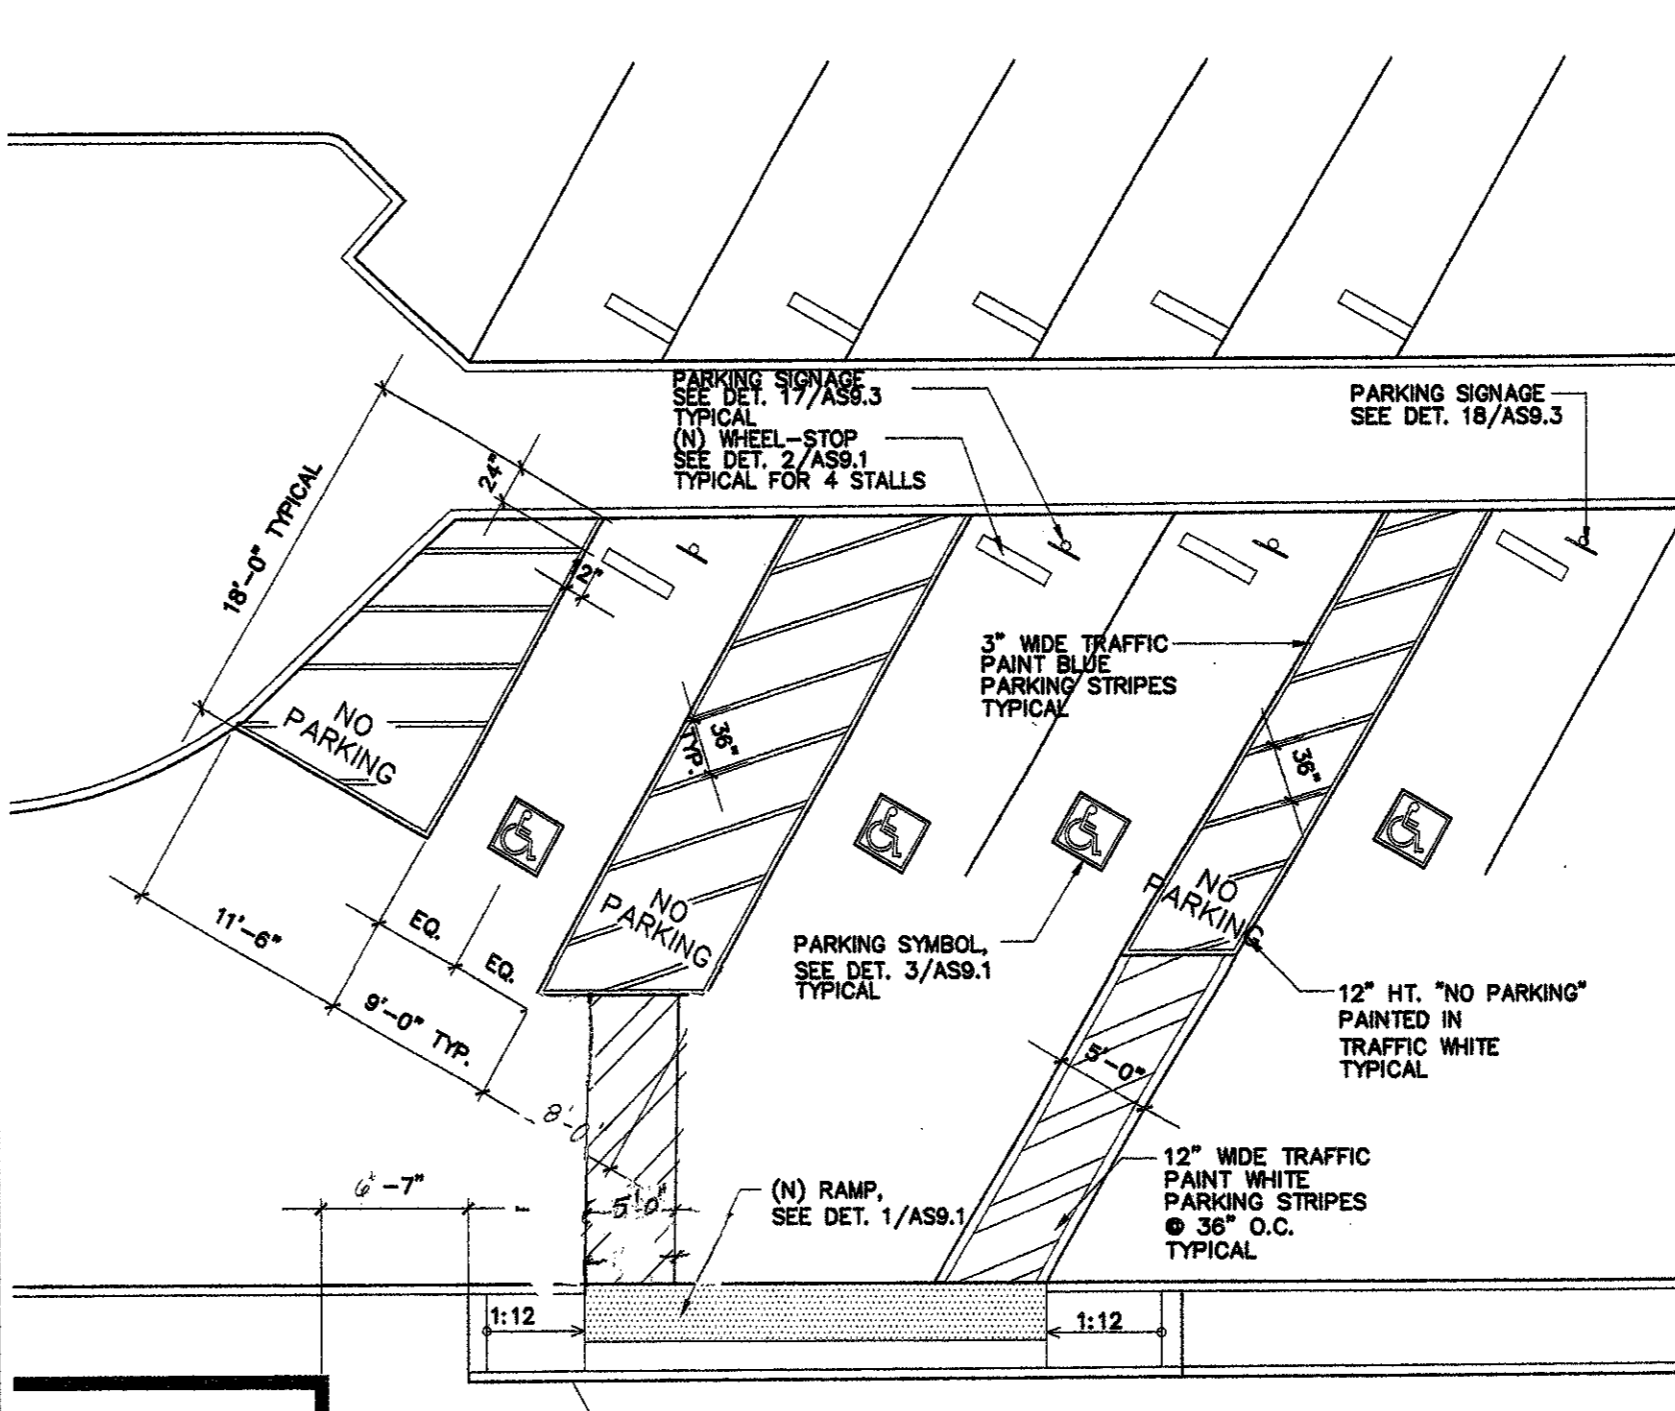

ENLARGED NEW PARKING PLAN

1"=10'-0" 2

1. (N) CRACK FILL / SEAL COAT APPROX: 160,000 SQFT. (N) WHEEL STOPS AND (N) PARKING STALL STRIPING TO MATCH (E) PARKING STALL LAYOUT OR AS DIRECTED BY DISTRICT / CM

REFERENCE NOTES

- RESTROOMS
- SCOPE OF WORK
- EXISTING FIRE HYDRANT

LEGEND

PATH OF TRAVEL (P.O.T.) AS INDICATED IS A BARRIER FREE ACCESS AT LEAST 48" WIDE WITHOUT ANY ABRUPT VERTICAL CHANGES EXCEEDING 1/2" AT 1:12 MAXIMUM SLOPE, EXCEPT THAT LEVEL CHANGES DO NOT EXCEED 1/4" VERTICAL. MAXIMUM CROSS-SLOPE 2% TYPICAL AND SLOPE IN THE DIRECTION OF TRAVEL DOES NOT EXCEED 5%. UNLESS OTHERWISE NOTED. THE CONTRACTOR SHALL VERIFY THAT ALL BARRIERS ON THE INDICATED PATH OF TRAVEL HAVE BEEN REMOVED.

PATH OF TRAVEL

| | | | |
|---|------------|------------|-------|
| TOTAL PARKING SPACES = 90 | STALL TYPE | | |
| ACCESSIBLE PARKING SPACE REQ'D (2001 CBC TABLE 11B-6) = 4 | STANDARD | ACCESSIBLE | TOTAL |
| | 86 | 3 | 89 |

PARKING TABULATION

2023 PAVING
STUDEBAKER ELEMENTARY SCHOOL
 11800 HALCOURT AVE
 NORWALK CA, 90650

OVERALL SITE PLAN

DRAWING NUMBER : AS1.1